




FILE NAME: G:\14 Jobs\14-013 Djibouti - Fuel Storage Facility - NAVFAC LANT\CAD AutoCAD\VA-101 PUMPHOUSE FLOOR PLAN.dwg LAYOUT NAME: PUMPHOUSE FLOOR PLAN PLOTTED: Friday, March 25, 2016 - 8:36am USER: wherrmann

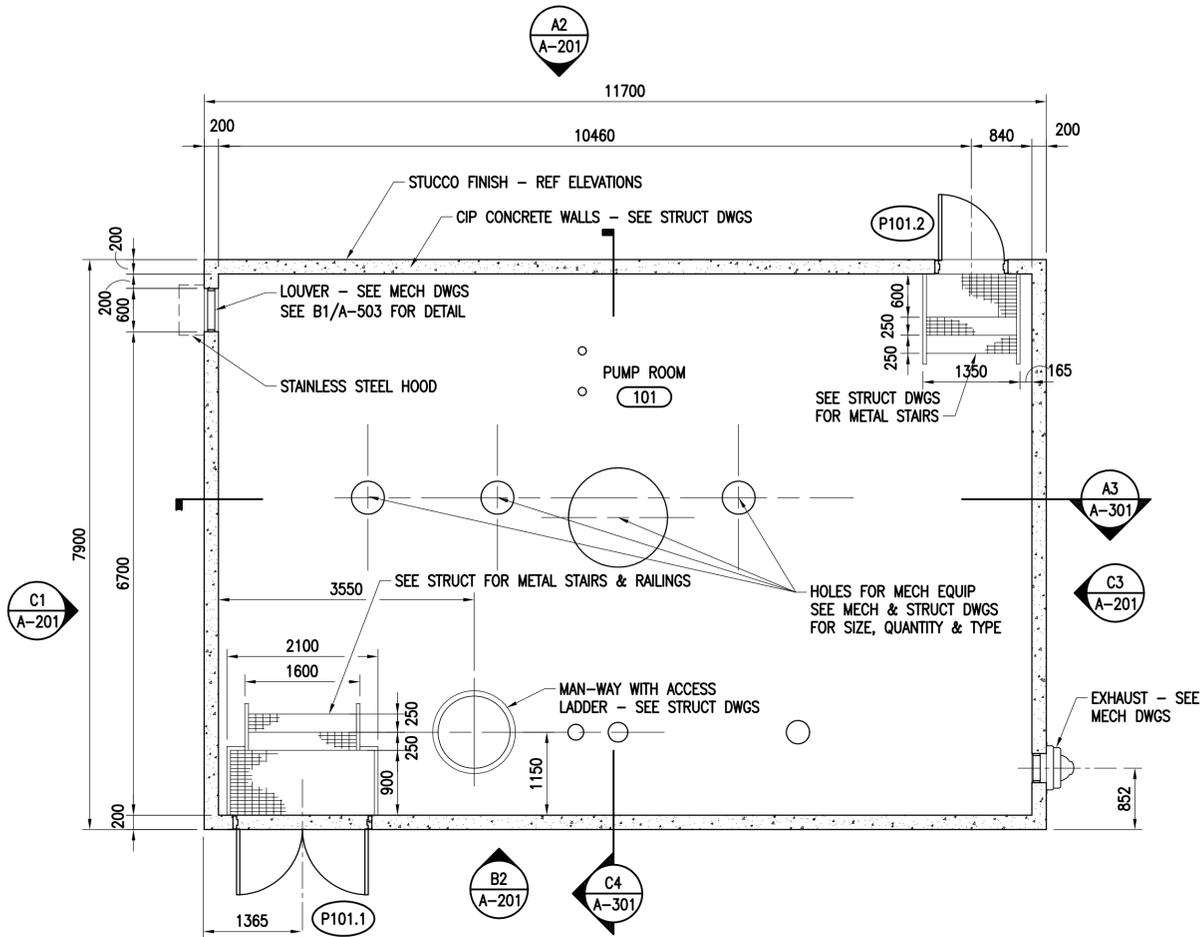

- NOTES:**
- (2) PUMP HOUSES ARE INCLUDED IN THE PROJECT.
 - DIMENSIONS OF CONCRETE/STUCCO WALLS ARE TO FACE OF CONCRETE UON.

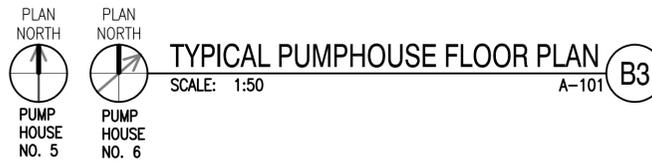

SYN	DESCRIPTION	DATE	APPR

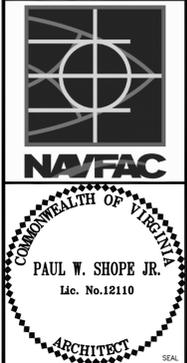


Austin
Brockenbrough
ENGINEERING - CONSULTING

APPROVED
FOR COMMANDER NAVFAC
ACTIVITY
SATISFACTORY TO DATE
DES: PWS | DRW: JRW | CHK: JTR
BRANCH MANAGER
CHIEF ENG/ARCH
<<<<<<>>


DEPARTMENT OF THE NAVY
ATLANTIC DIVISION
CAMP LEMONNIER
NAVAL FACILITIES ENGINEERING COMMAND
NAVAL FACILITIES ENGINEERING COMMAND
NORFOLK, VIRGINIA
DIBOUTI, AFRICA
DESC 1701/P-1701
CONSTRUCT FUEL STORAGE FACILITIES
PUMPHOUSE FLOOR PLAN

SCALE: AS NOTED
PROJECT NO.:
WORK ORDER NO.:
NAVFAC DRAWING NO: 14047047
SHEET 83 OF 186
A-101
DRAWN/REVISED: 10 MARCH 2009

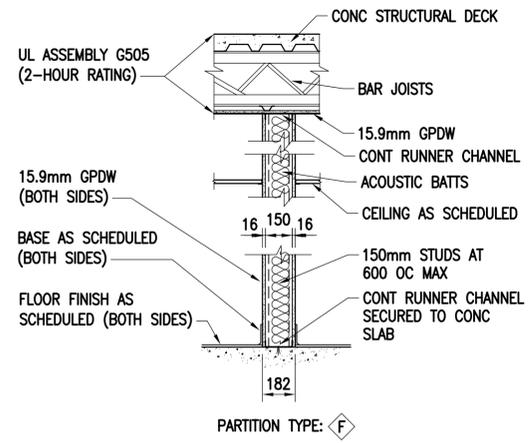


FILTER BUILDING PARTITION DETAIL
SCALE: 1:20

A-103 **D1**

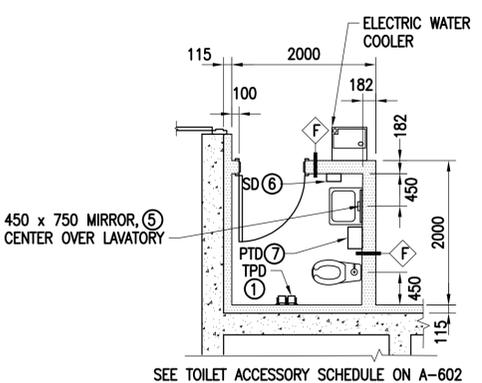

ENLARGED TOILET PLAN
SCALE: 1:50


A-103 **D2**

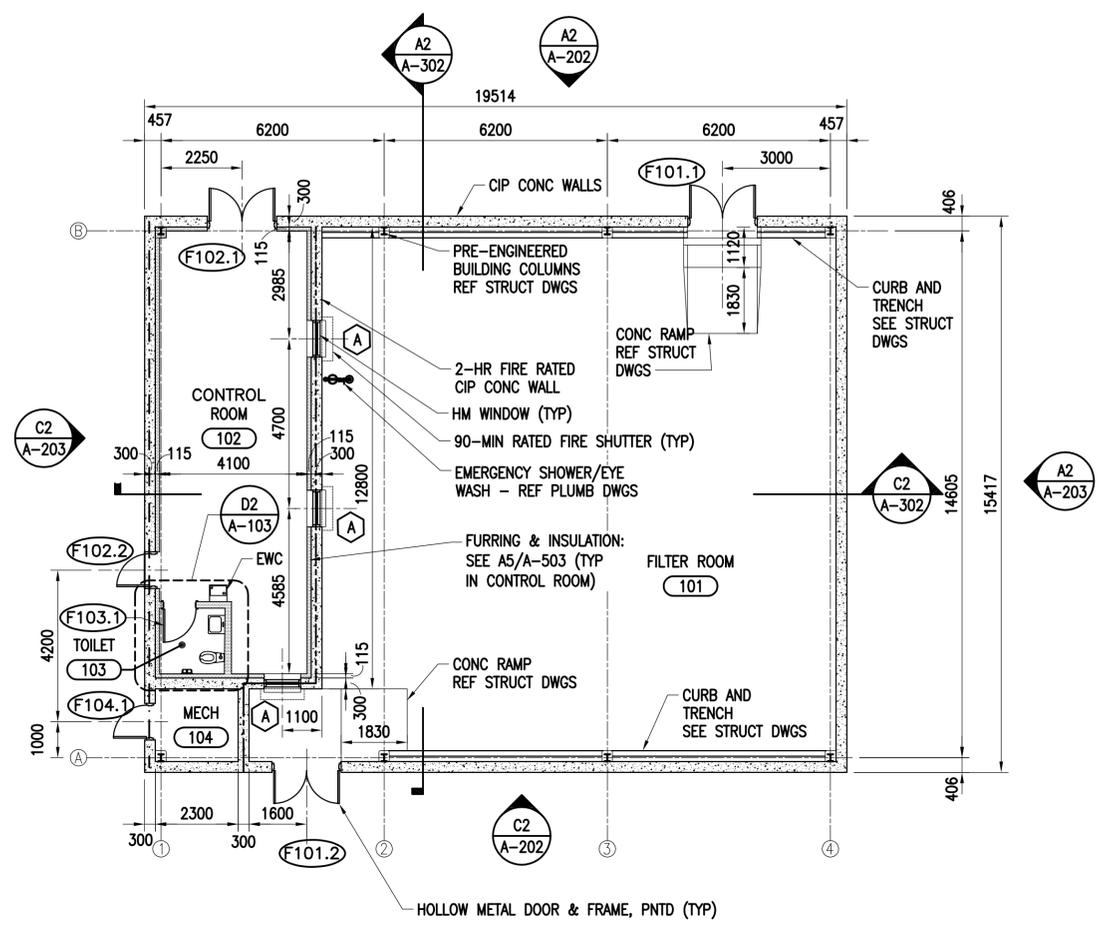

NOTES: DIMENSIONS OF CONCRETE/STUCCO WALLS ARE TO FACE OF CONCRETE UN. SEE C2/A-104 FOR REFLECTED CEILING PLAN.


FILTER BUILDING FLOOR PLAN
SCALE: 1:100

PLAN LEGEND	
---	2-HOUR FIRE BARRIER IN ACCORDANCE WITH IBC 722.2.2.1 FOR CONCRETE WALLS (OPENING PROTECTION REQUIRED THIS SIDE)
---	2-HOUR FIRE BARRIER IN ACCORDANCE WITH IBC 722.2.2.1 FOR SUPPORTING RATED FLOOR/CEILING ABOVE (OPENING PROTECTION NOT REQUIRED THIS SIDE)

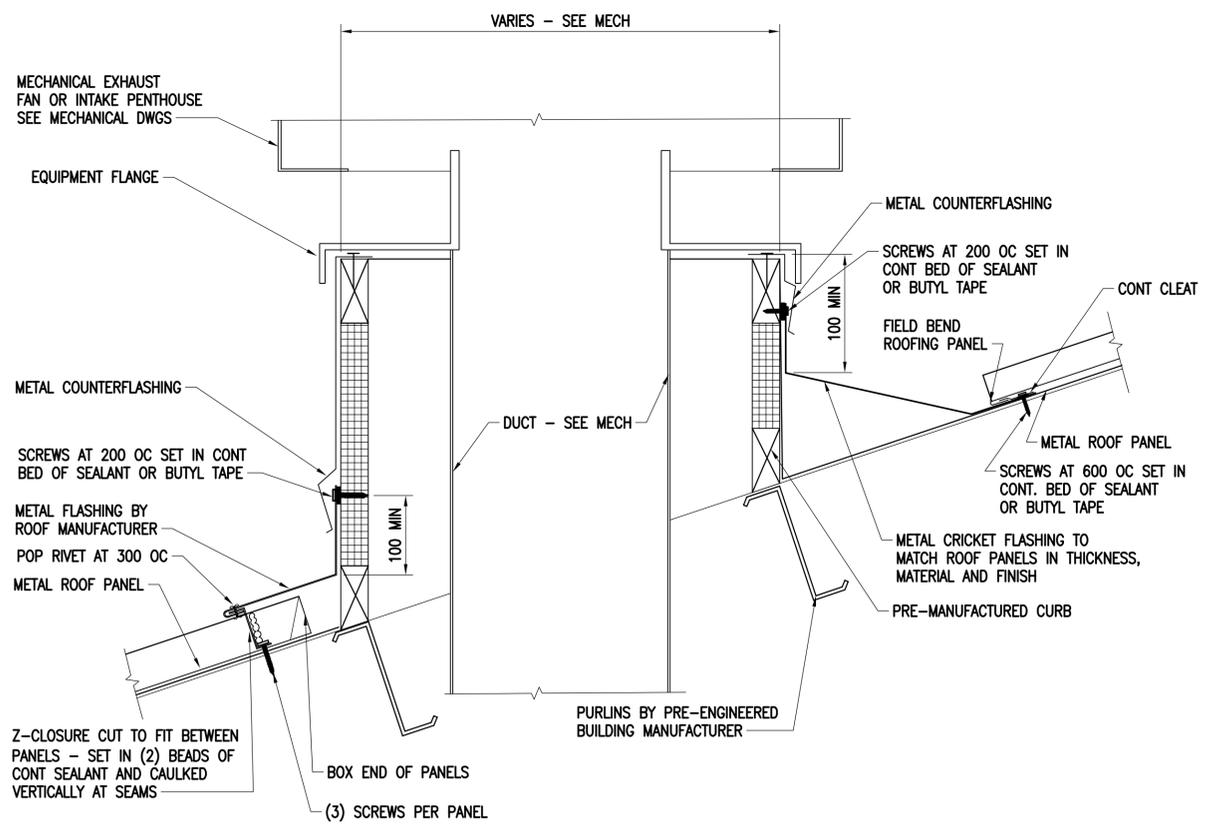

ROOF CURB DETAIL
SCALE: 1:5

A-104 **A1**

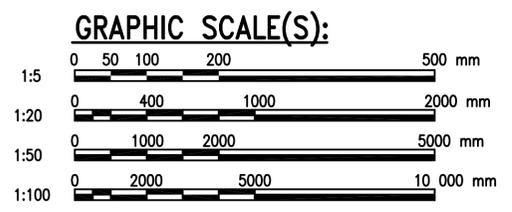


APPR	DATE
SYN	DESCRIPTION
APPROVED	A/E INFO
FOR COMMANDER NAVFAC	ACTIVITY
SATISFACTORY TO	DATE
DES: PWS	DRW: JRW
CHK: JTR	
BRANCH MANAGER	
CHIEF ENG/ARCH	
DEPARTMENT OF THE NAVY	NAVAL FACILITIES ENGINEERING COMMAND
ATLANTIC DIVISION	NAVFAC LANT/DAV-103
CAMP LEMONIER	DUBOULT, AFRICA
DESC 1701/P-1701 CONSTRUCT FUEL STORAGE FACILITIES FILTER BUILDING FLOOR PLAN	
SCALE:	AS NOTED
PROJECT NO.:	
WORK ORDER NO.:	
NAVFAC DRAWING NO.:	14047049
SHEET	85 OF 186
A-103	
<small>DRAWFORM REVISION: 10 MARCH 2009</small>	


FILE NAME: G:\14 Jobs\14-013 Dlubout - Fuel Storage Facility - NAVFAC LANT/DAV-103 FILTER BUILDING FLOOR PLAN.dwg LAYOUT NAME: FILTER BUILDING FLOOR PLAN PLOTTED: Friday, March 25, 2016 - 8:36am USER: wherrmann

1 2 3 4 5


REFLECTED CEILING PLAN LEGEND			
	610mm x 610mm SUSPENDED ACOUSTIC CEILING PANEL CEILING TILES & GRID		MECHANICAL SUPPLY DIFFUSER - SEE MECHANICAL DWGS
	610mm x 1,220mm RECESS MOUNTED FLUORESCENT LIGHT FIXTURE - SEE ELEC DWGS		MECHANICAL RETURN OR EXHAUST GRILLE - SEE MECHANICAL DWGS
	610mm x 610mm RECESS MOUNTED FLUORESCENT LIGHT FIXTURE - SEE ELEC DWGS		GPDW CEILING
	PENDANT MOUNTED LIGHT FIXTURE - SEE ELEC DWGS	NOTE: MECHANICAL & ELECTRICAL ITEMS ARE SHOWN ON THIS PLAN FOR GENERAL LOCATION & COORDINATION ONLY. REF MECH & ELEC DWGS SCHEDULES FOR QUANTITY & INFORMATION ON THESE ITEMS.	

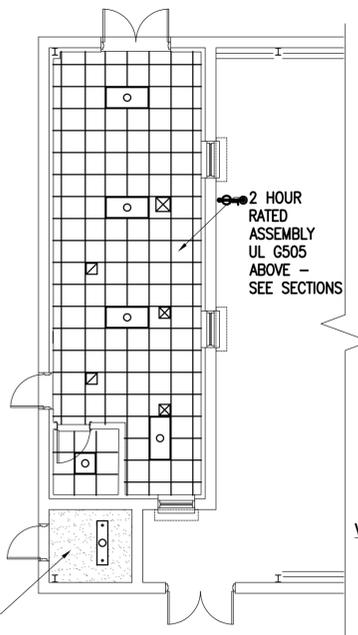


PLAN NORTH
FILTER BUILDING - PARTIAL REFLECTED CEILING PLAN
 SCALE: 1:100 A-103 C2

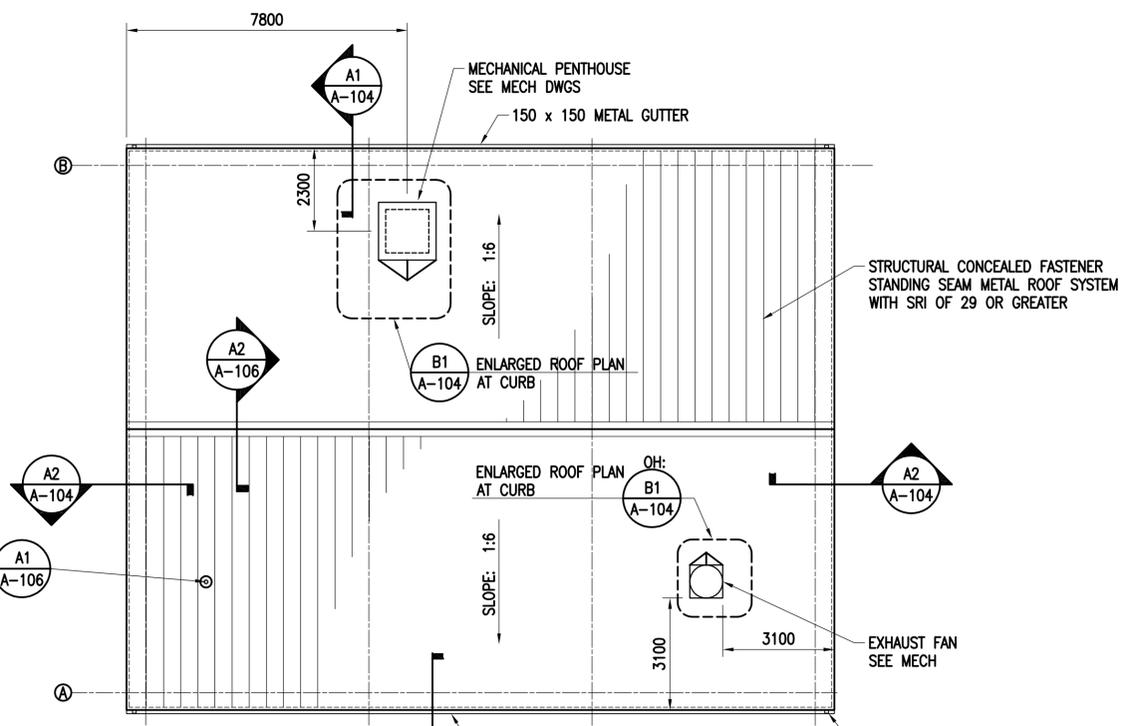


PLAN NORTH
FILTER BUILDING ROOF PLAN
 SCALE: 1:100 A-104 C3

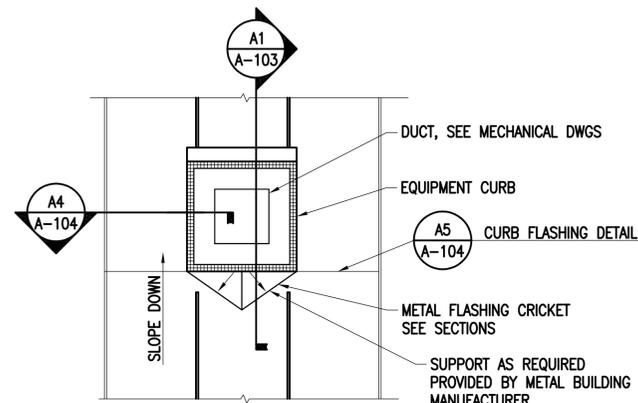


ENLARGED ROOF PLAN AT CURB
 SCALE: 1:20 A-104 B1

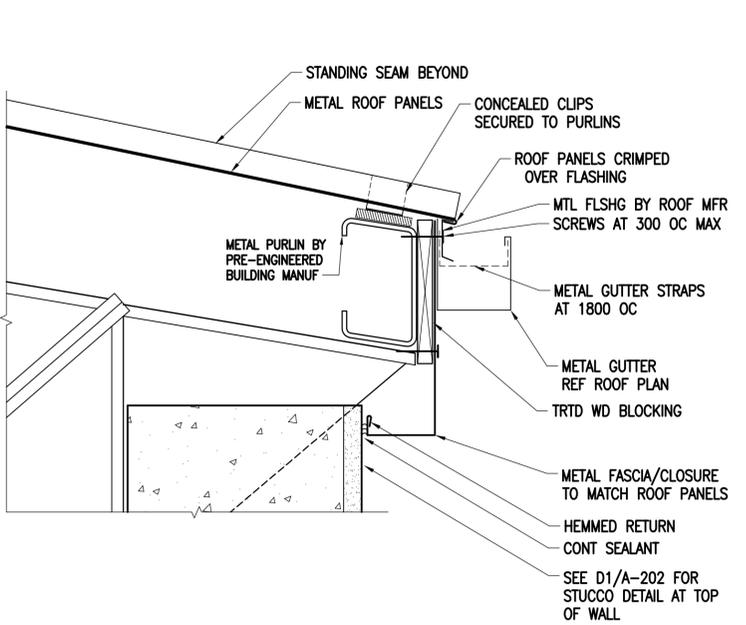


SECTION
 SCALE: 1:5 A-104 A1

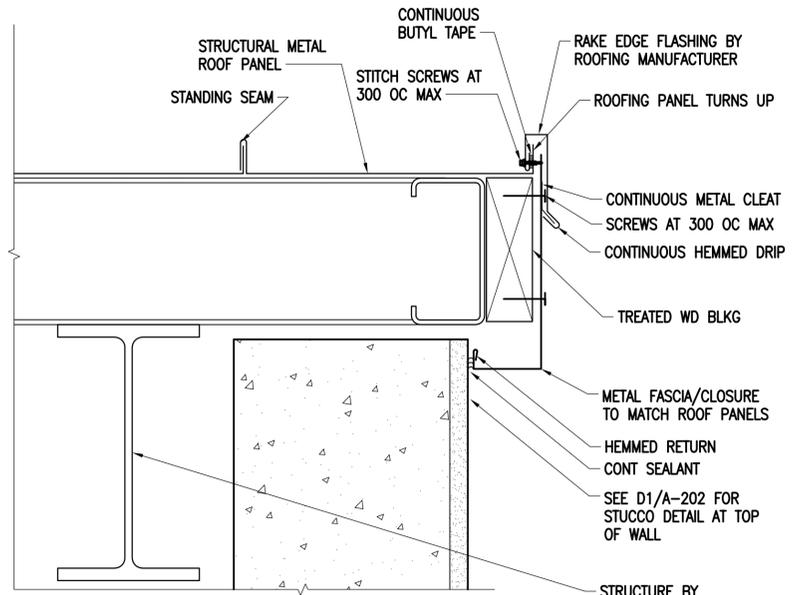


SECTION
 SCALE: 1:5 A-104 A2

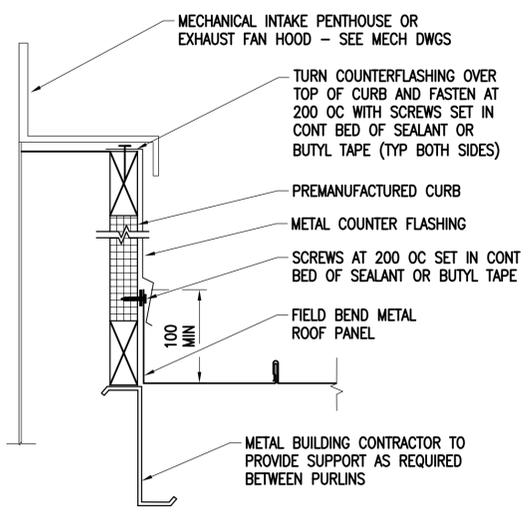

SECTION
 SCALE: 1:5 A-104 A4

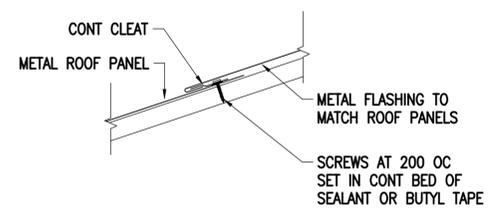


CURB FLASHING DETAIL
 SCALE: 1:5 A-104 A5

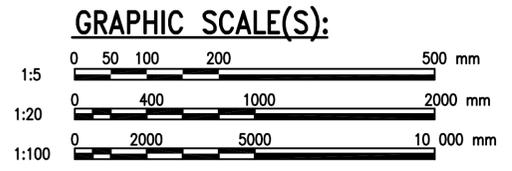

APPR	
DATE	
SYN	DESCRIPTION
 NAVFAC COMMONWEALTH OF VIRGINIA PAUL W. SHOPE JR. Lic. No. 12110 ARCHITECT	
Austin Brockenbrough ENGINEERING - CONSULTING	
APPROVED	A/E INFO
FOR COMMANDER NAVFAC ACTIVITY	
SATISFACTORY TO	DATE
DES PWS	DRW JRW
CHK JTR	
BRANCH MANAGER	
CHIEF ENG/ARCH	
NAVFACILITIES ENGINEERING COMMAND	
NAVFACILITIES ENGINEERING COMMAND	
DIBOUTI AFRICA	
DESC 1701/P-1701	
CONSTRUCT FUEL STORAGE FACILITIES	
FILTER BUILDING ROOF & REFLECTED CEILING PLANS	
SCALE:	AS NOTED
PROJECT NO.:	14047050
WORK ORDER NO.:	
NAVFAC DRAWING NO.:	14047050
SHEET	86 OF 186
A-104	
DRAWFORM REVISION: 10 MARCH 2009	


FILE NAME: G:\14 Jobs\14-013 Djbouti - Fuel Storage Facility - NAVFAC LANTCOM Ainc040VA-104 FILTER BUILDING ROOF & REFLECTED CEILING PLANS.dwg LAYOUT NAME: FILTER BUILDING ROOF & REFLECTED CEILING PLANS.dwg

FILE NAME: G:\14 Jobs\14-013 Djibouti - Fuel Storage Facility - NAVFAC LANT\CAD AutoCAD\VA-105 OPERATIONS BUILDING FLOOR PLAN.dwg LAYOUT NAME: OPERATIONS BUILDING FLOOR PLAN PLOTTED: Friday, March 25, 2016 - 8:37am USER: whitemann

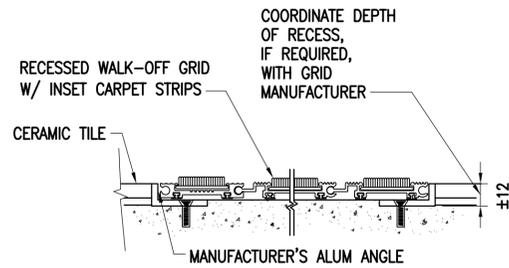

ENTRANCE GRID DETAIL
SCALE: 1:2 A-105 (D2)

RECESSED WALK-OFF GRID,
RECESS FLOOR SLAB AS REQUIRED,
COORDINATE DEPTH W/ MFR
SEE D2/A-105

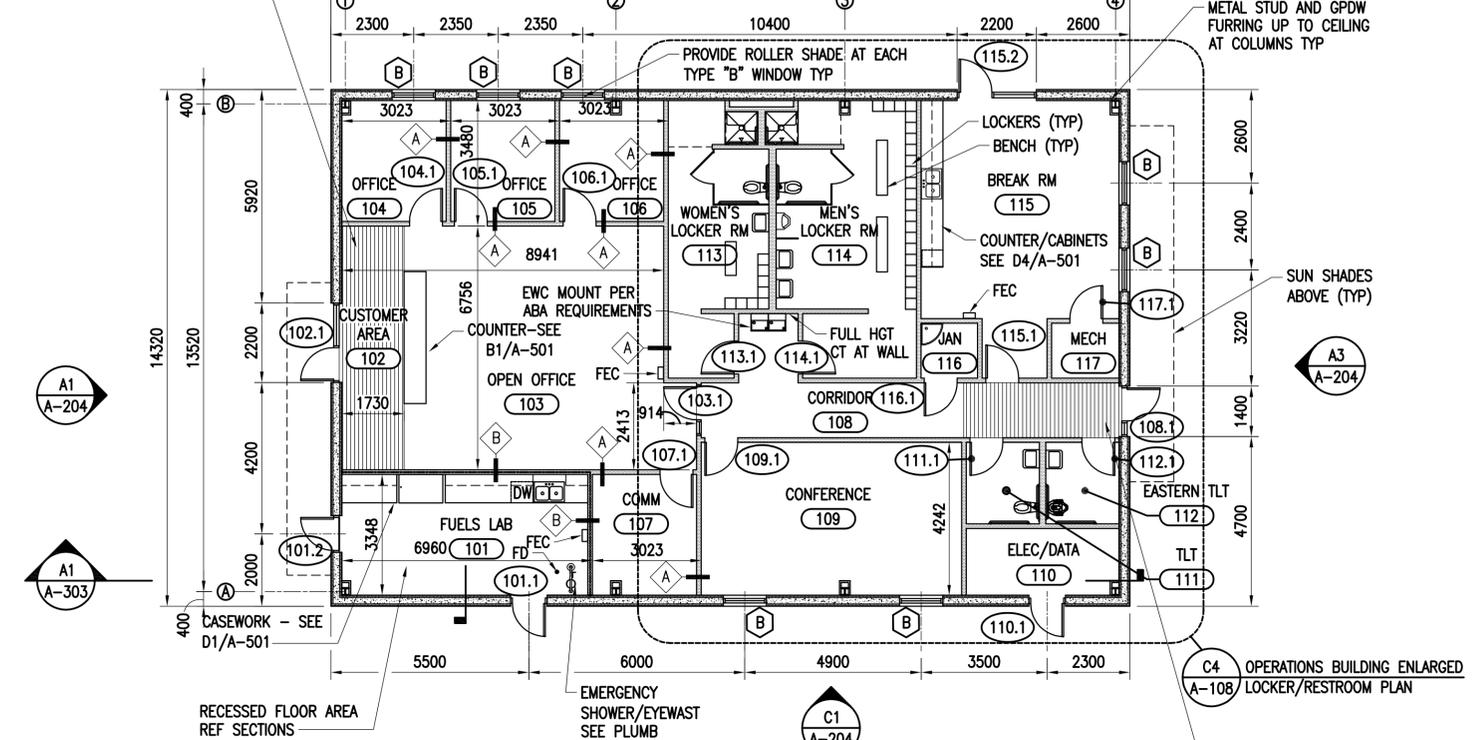


NOTE: SEE C3/A-107 FOR REFLECTED CEILING PLAN

PLAN NORTH
OPERATIONS BUILDING FLOOR PLAN
SCALE: 1:100 A-105 (C3)


PLAN LEGEND	
	2 HOUR FIRE BARRIER UL U419

PLAN NOTES:

1. PROVIDE ROLLER SHADES AT ALL TYPE "B" WINDOWS. REF: SPECIFICATIONS.
2. FEC'S TO BE SEMI-RECESSED UON.
3. EXTERIOR WALLS ARE DIMENSIONED TO FACE OF INSULATED FORM UON.

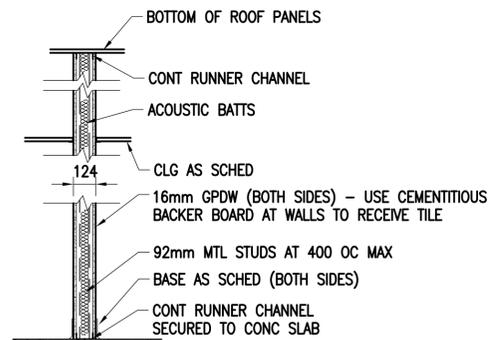


PARTITION TYPE A
SCALE: 1:20 A-105 (A3)

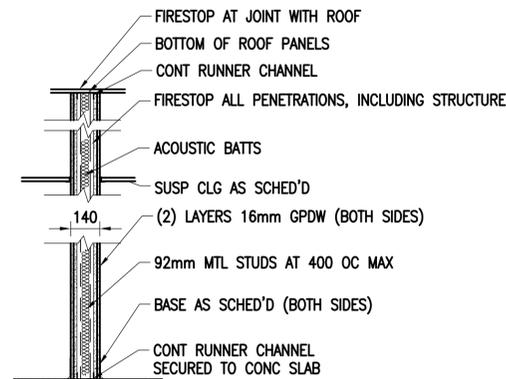


PARTITION TYPE B
SCALE: 1:20 A-105 A-303 (A4)

GRAPHIC SCALE(S):

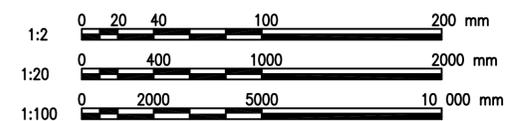


APPR	
DATE	
SYN	DESCRIPTION
 NAVFAC COMMONWEALTH OF VIRGINIA PAUL W. SHOPE JR. Lic. No. 12110 ARCHITECT	
Austin Brockenbrough ENGINEERING - CONSULTING	
APPROVED	A/E INFO
FOR COMMANDER NAVFAC	ACTIVITY
SATISFACTORY TO	DATE
DES: PWS	DRW: JRW
<<PM/DM>>	CHK: JTR
BRANCH MANAGER	
CHIEF ENG/ARCH	
<<CR>>	
NAVAL FACILITIES ENGINEERING COMMAND	DUBOITI, AFRICA
NAVAL FACILITIES ENGINEERING COMMAND	NORFOLK, VIRGINIA
ATLANTIC DIVISION	CAMP LEMONNIER
DESC 1701/P-1701 CONSTRUCT FUEL STORAGE FACILITIES OPERATIONS BUILDING FLOOR PLAN	
SCALE:	AS NOTED
PROJECT NO.:	
WORK ORDER NO.:	
NAVFAC DRAWING NO.:	14047051
SHEET	87 OF 186
A-105	
DRAWFORM REVISION: 10 MARCH 2009	


FILE NAME: G:\14 Jobs\14-013 Djibouti - Fuel Storage Facility - NAVFAC LANTCOM Aue040VA-107 OPERATIONS BUILDING REFLECTED CEILING PLAN LAYOUT NAME: OPERATIONS BUILDING REFLECTED CEILING PLAN PLOTTED: Friday, March 25, 2016 - 8:38am USER: wherrmann

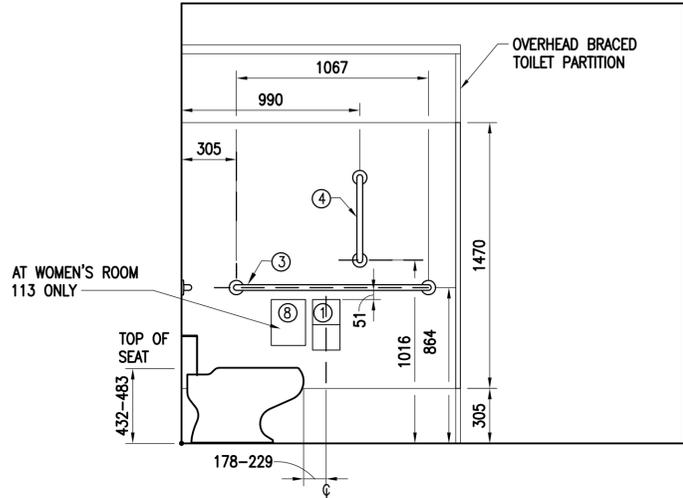


ELEV - WOMEN'S LOCKER RM 113
MEN'S RM 114 SIM OPP HAND
 SCALE: 1:20 A-108 C1

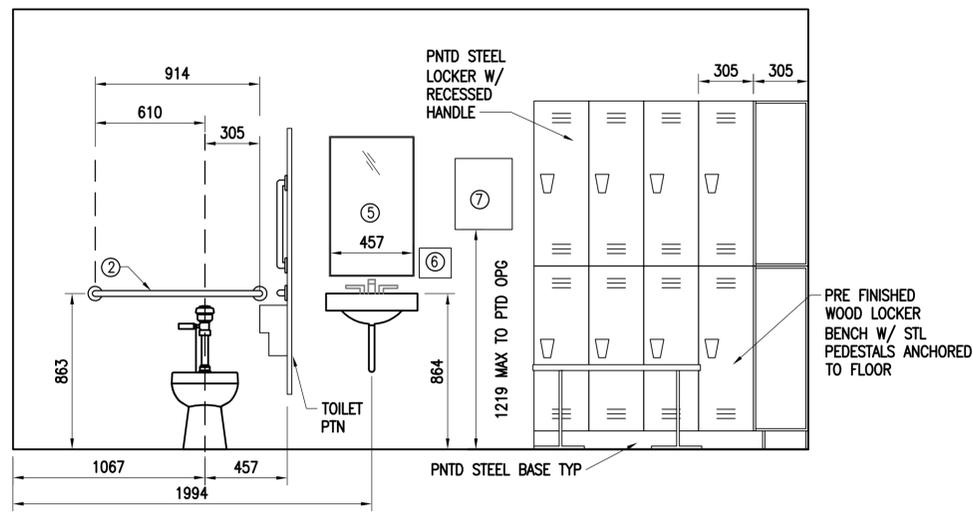

ELEV - WOMEN'S LOCKER RM 113
 SCALE: 1:20 A-108 A1

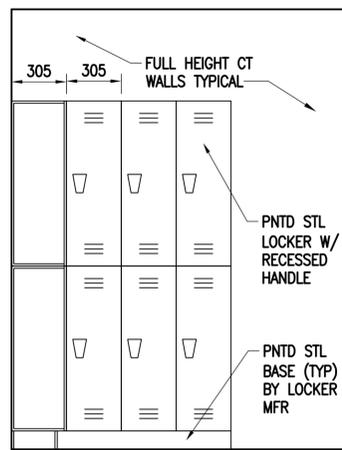

ELEV - WOMEN'S LOCKER RM 113
 SCALE: 1:20 A-108 A3

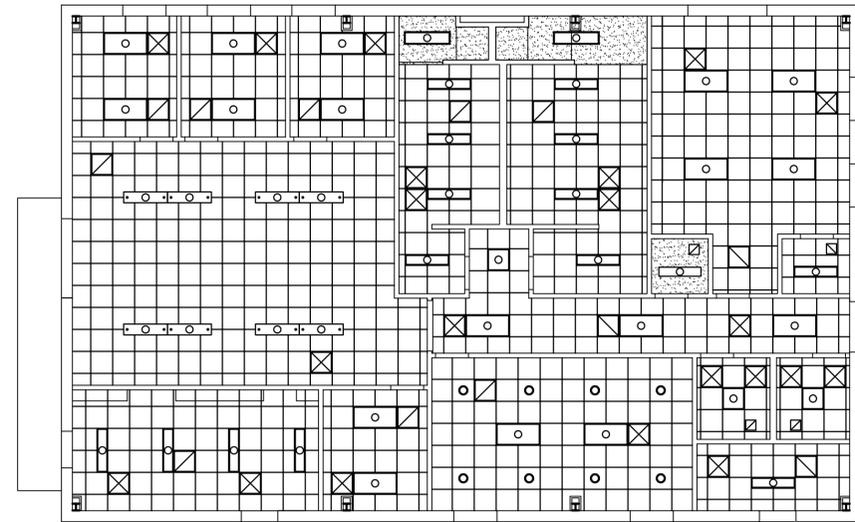


OPERATIONS BUILDING
REFLECTED CEILING PLAN
 SCALE: 1:100 A-105 C3

EXTERIOR SUN SHADES (TYP) SEE ELEVATIONS


	610mm x 610mm SUSPENDED ACOUSTIC CEILING PANEL CEILING TILES & GRID		610mm x 610mm RECESS MOUNTED FLUORESCENT LIGHT FIXTURE - SEE ELEC DWGS
	MOISTURE-RESISTANT GYPSUM DRYWALL CEILING & METAL SUSPENSION SYSTEM		RECESSED DOWN-LIGHT FIXTURE - SEE ELEC DWGS
	610mm x 1220mm RECESS MOUNTED FLUORESCENT LIGHT FIXTURE - SEE ELEC DWGS		PENDANT MOUNTED LIGHT FIXTURE - SEE ELEC DWGS
	305mm x 1220mm RECESS MOUNTED FLUORESCENT LIGHT FIXTURE - SEE ELEC DWGS		MECHANICAL SUPPLY DIFFUSER - SEE MECHANICAL DWGS
			MECHANICAL RETURN OR EXHAUST GRILLE - SEE MECHANICAL DWGS

NOTE: MECHANICAL & ELECTRICAL ITEMS ARE SHOWN ON THIS PLAN FOR GENERAL LOCATION & COORDINATION ONLY. REF MECH & ELEC DRAWINGS & SCHEDULES FOR QUANTITY & INFORMATION ON THESE ITEMS.

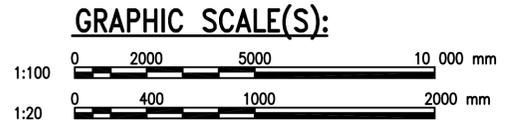


APPR	
DATE	
DESCRIPTION	
SYN	
 NAVFAC COMMONWEALTH OF VIRGINIA PAUL W. SHOPE JR. Lic. No. 12110 ARCHITECT	
Austin Brockenbrough ENGINEERING - CONSULTING	
APPROVED	A/E INFO
FOR COMMANDER NAVFAC	ACTIVITY
SATISFACTORY TO	DATE
DES: PWS	DRW: JRW
CHK: JTR	
BRANCH MANAGER	
CHIEF ENG/ARCH	
NAVFAC LANTCOM AUE040VA-107	NAVAL FACILITIES ENGINEERING COMMAND
ATLANTIC DIVISION	NAVFAC LANTCOM AUE040VA-107
CAMP LEMONNIER	DUBOULT AFRICA
DESC 1701/P-1701 CONSTRUCT FUEL STORAGE FACILITIES OPERATIONS BUILDING REFLECTED CEILING PLAN	
SCALE:	AS NOTED
PROJECT NO.:	
WORK ORDER NO.:	
NAVFAC DRAWING NO.:	14047053
SHEET	89 OF 186
A-107	
DRAWFORM REVISION: 10 MARCH 2009	


FILE NAME: G:\14 Jobs\14-013 Djibouti - Fuel Storage Facility - NAVFAC LANT\CAD AutoCAD\VA-109 OPERATIONS BUILDING FURNISHINGS AND EQUIPMENT PLAN.dwg LAYOUT NAME: OPERATIONS BUILDING FURNISHINGS AND EQUIPMENT PLAN PLOTTED: Friday, March 25, 2016 - 8:38am USER: whermann

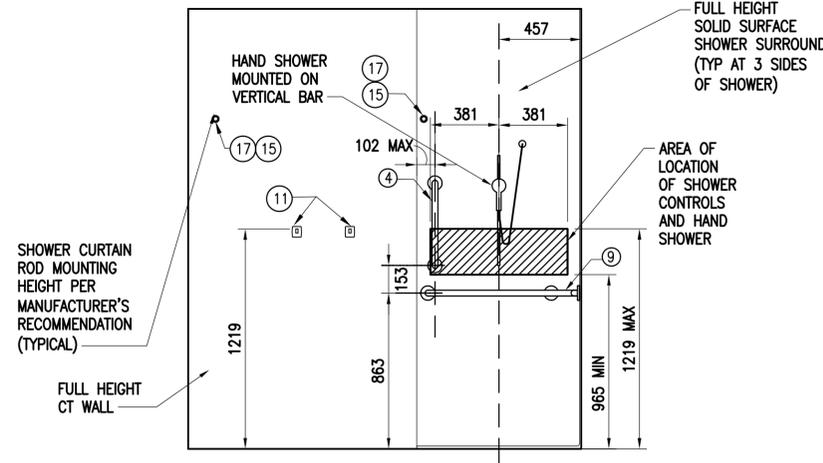


ELEV - MEN'S LOCKER RM 114
SCALE: 1:20 A-108 (D1)

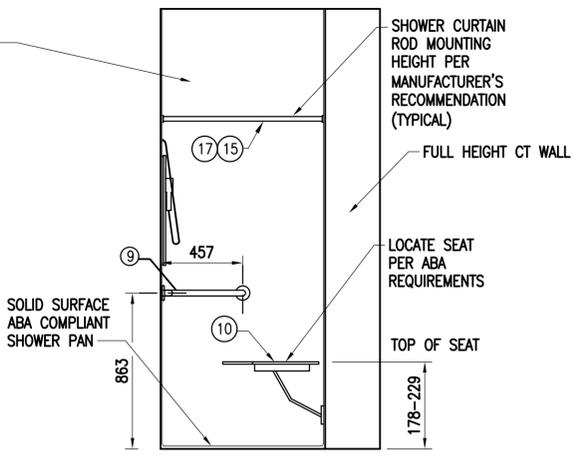

ELEV - MEN'S LOCKER RM 114
SCALE: 1:20 A-108 (D2)

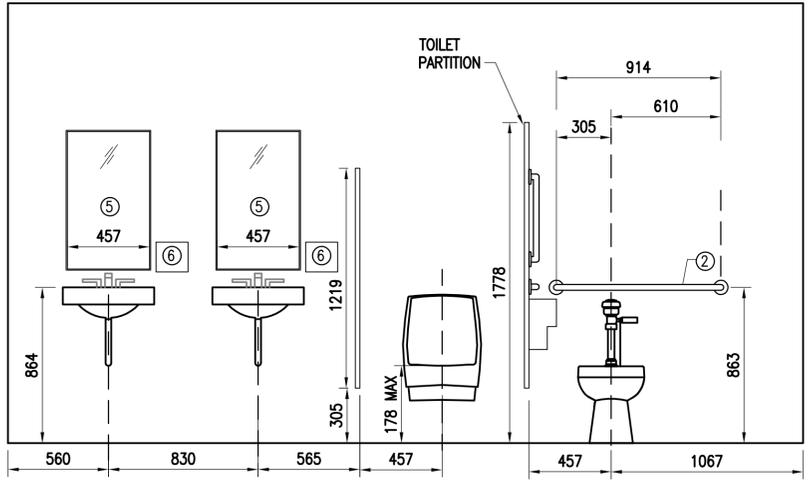


ELEV - MEN'S LOCKER RM 114
SCALE: 1:20 A-108 (C1)

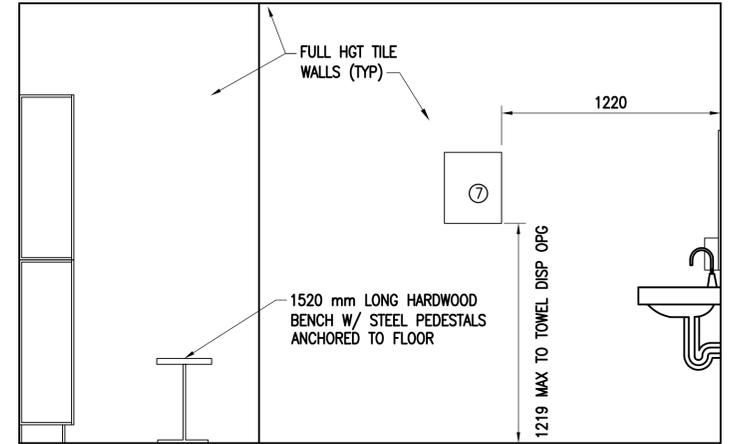


ELEV - MEN'S LOCKER RM 114
SCALE: 1:20 A-108 (C2)



ELEV - MEN'S LOCKER RM 114
SCALE: 1:20 A-108 (A1)

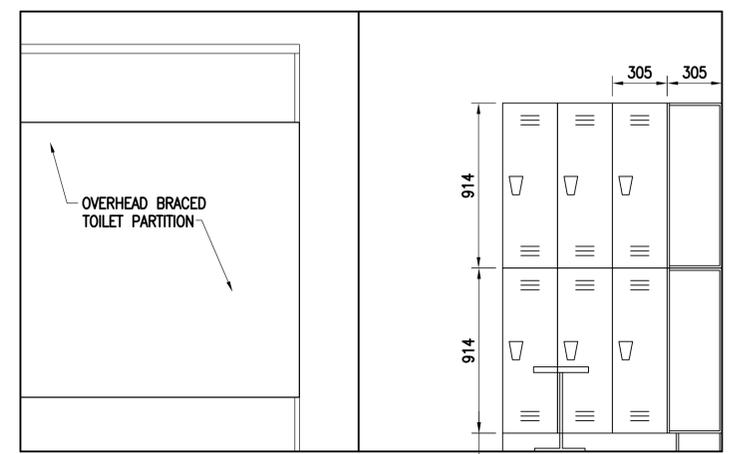


ELEV - MEN'S LOCKER RM 114
SCALE: 1:20 A-108 (A4)

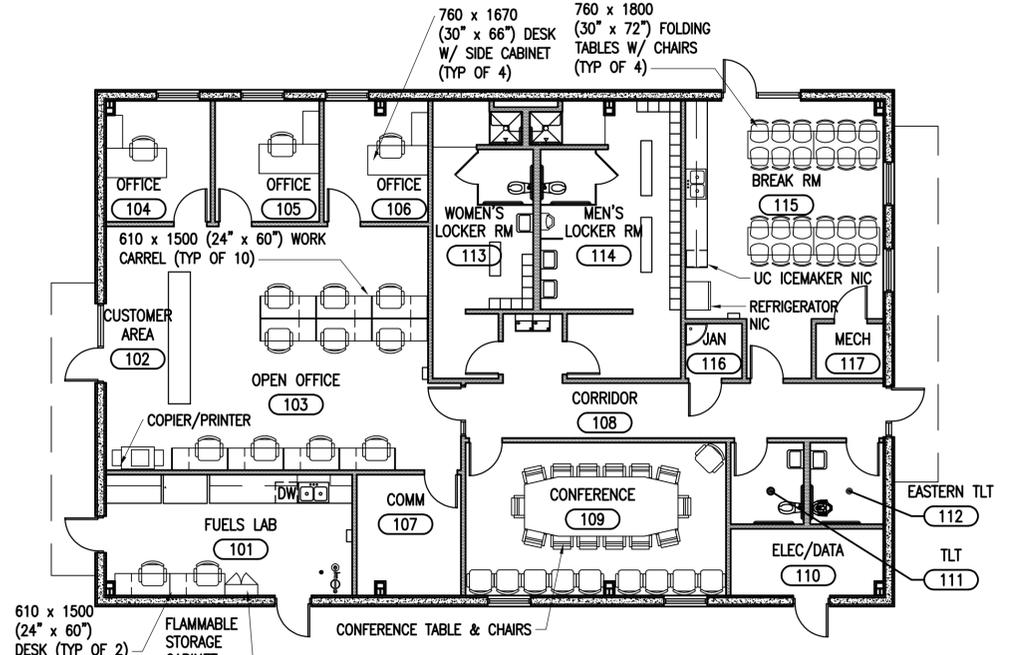


OPERATIONS BUILDING
FURNISHINGS AND EQUIPMENT PLAN
SCALE: 1:100 (C3)

NOTE: ALL FURNITURE & EQUIPMENT SHOWN IS BY OTHERS UNLESS SHOWN ON THE FLOOR PLAN DRAWING ON SHEET A-105 OR SHEET A-108

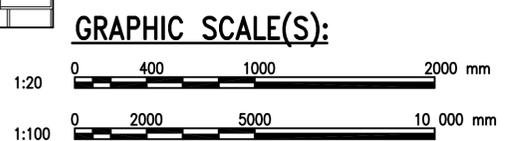


Project information including title block, logos for NAVFAC and Brockenbrough, and project details: DESC 1701/P-1701 CONSTRUCT FUEL STORAGE FACILITIES, OPERATIONS BUILDING FURNISHINGS AND EQUIPMENT PLAN.


FILE NAME: G:\14 Jobs\14-013 Djbouti - Fuel Storage Facility - NAVFAC LANT\CAD AutoCAD\A-201 PUMPHOUSE ELEVATIONS.dwg LAYOUT NAME: PUMPHOUSE ELEVATIONS PLOTTED: Friday, March 25, 2016 - 8:38am USER: wharrmann

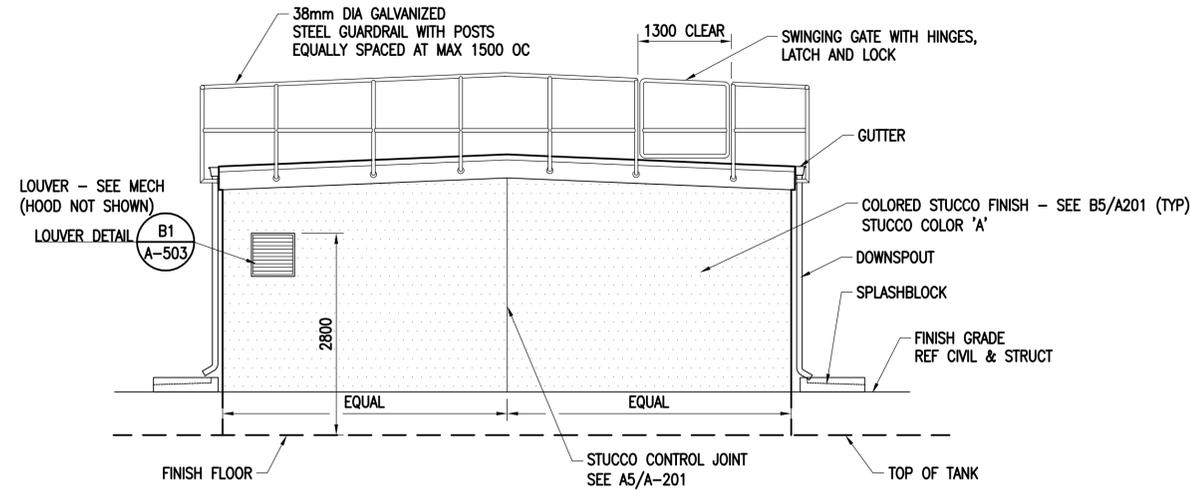


**TYPICAL PUMPHOUSE
EXTERIOR ELEVATION C1**
SCALE: 1:50 A-101

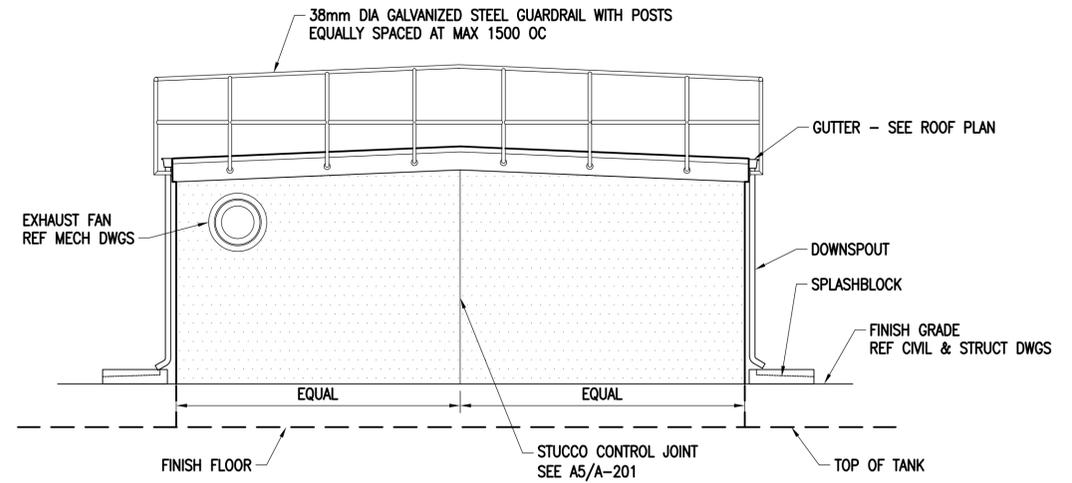


**TYPICAL PUMPHOUSE
EXTERIOR ELEVATION C3**
SCALE: 1:50 A-101

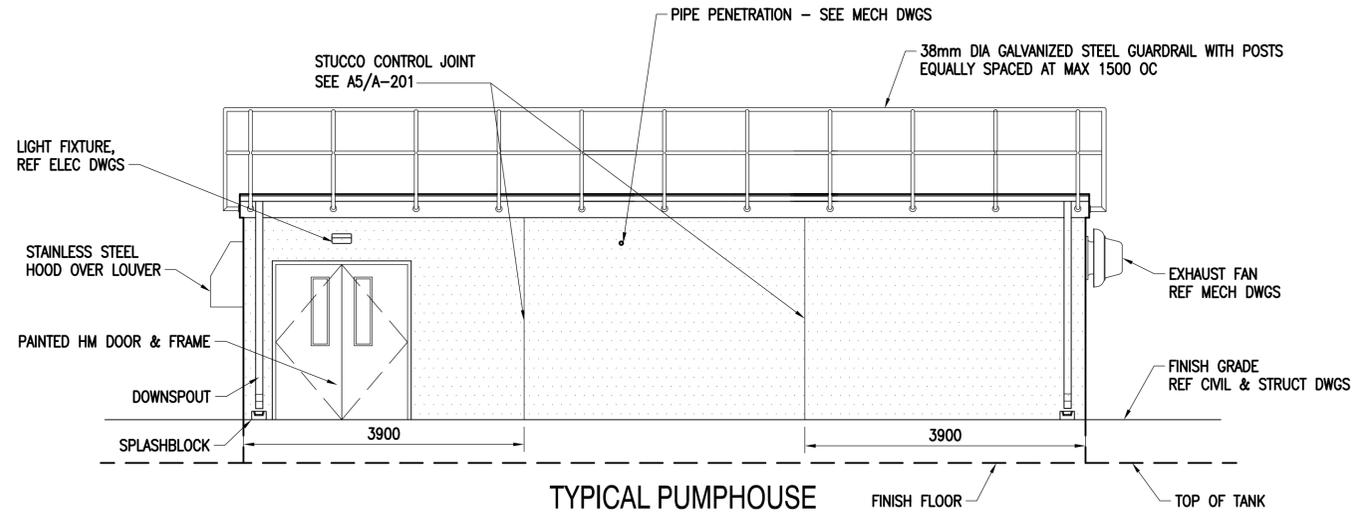


**TYPICAL PUMPHOUSE
EXTERIOR ELEVATION B2**
SCALE: 1:50 A-101

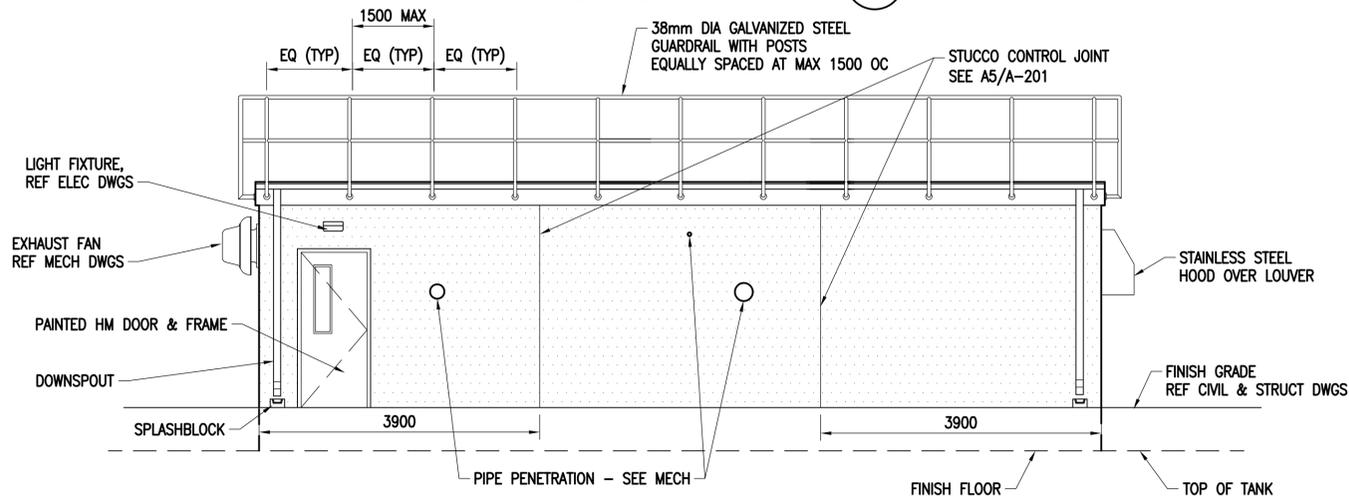


**TYPICAL PUMPHOUSE
EXTERIOR ELEVATION A2**
SCALE: 1:50 A-101

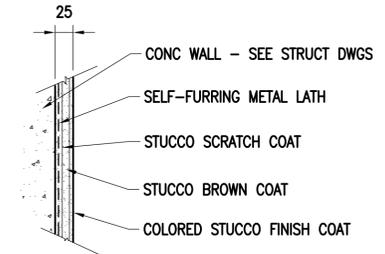

TYPICAL STUCCO OVER CONCRETE DETAIL B5
SCALE: 1:5 A-201 A-202 A-203 A-301 A-502 A-503

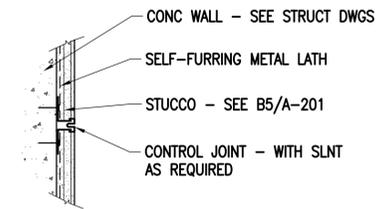


TYPICAL STUCCO CONTROL JOINT DETAIL A5
SCALE: 1:5 A-201 A-202 A-203

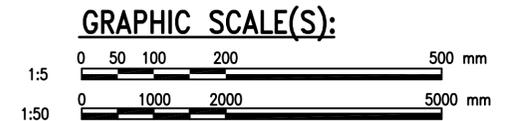


APPROVED	DATE	DESCRIPTION	SYN
 NAVFAC COMMONWEALTH OF VIRGINIA PAUL W. SHOPE JR. Lic. No. 12110 ARCHITECT			
Austin Brockenbrough ENGINEERING - CONSULTING			
APPROVED	A/E INFO		
FOR COMMANDER NAVFAC	ACTIVITY		
SATISFACTORY TO	DATE		
DES PWS	DRW JRW	CHK JTR	
<<PM/DM>>			
BRANCH MANAGER			
CHIEF ENG/ARCH			
<<<<>>			
DEPARTMENT OF THE NAVY	NAVAL FACILITIES ENGINEERING COMMAND	NAVFAC LANT	AFRICA
ATLANTIC DIVISION	NAVAL FACILITIES ENGINEERING COMMAND	NAVFAC LANT	DUBOITI AFRICA
CAMP LEMONNIER	NAVFAC LANT	NAVFAC LANT	DUBOITI AFRICA
DESC 1701/P-1701 CONSTRUCT FUEL STORAGE FACILITIES PUMPHOUSE ELEVATIONS			
SCALE:	AS NOTED		
PROJECT NO.:			
WORK ORDER NO.:			
NAVFAC DRAWING NO.:	14047056		
SHEET	92	OF	186
A-201			
DRAWING REVISION: 10 MARCH 2009			


FILE NAME: G:\14 Jobs\14-013 Djibouti - Fuel Storage Facility - NAVFAC LANT\CAD AutoCAD\VA-202 FILTER BUILDING ELEVATIONS.dwg LAYOUT NAME: FILTER BUILDING ELEVATIONS PLOTTED: Friday, March 25, 2016 - 8:38am USER: wherrmann

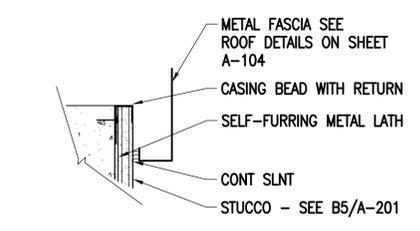


STUCCO DETAIL AT TOP OF WALL
SCALE: 1:5
A-104
A-302
D1

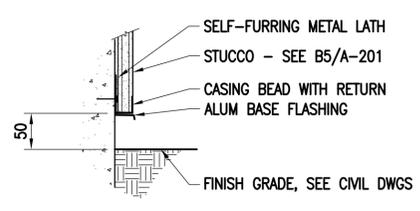


STUCCO DETAIL AT BOTTOM OF WALL
SCALE: 1:5
A-302
C1

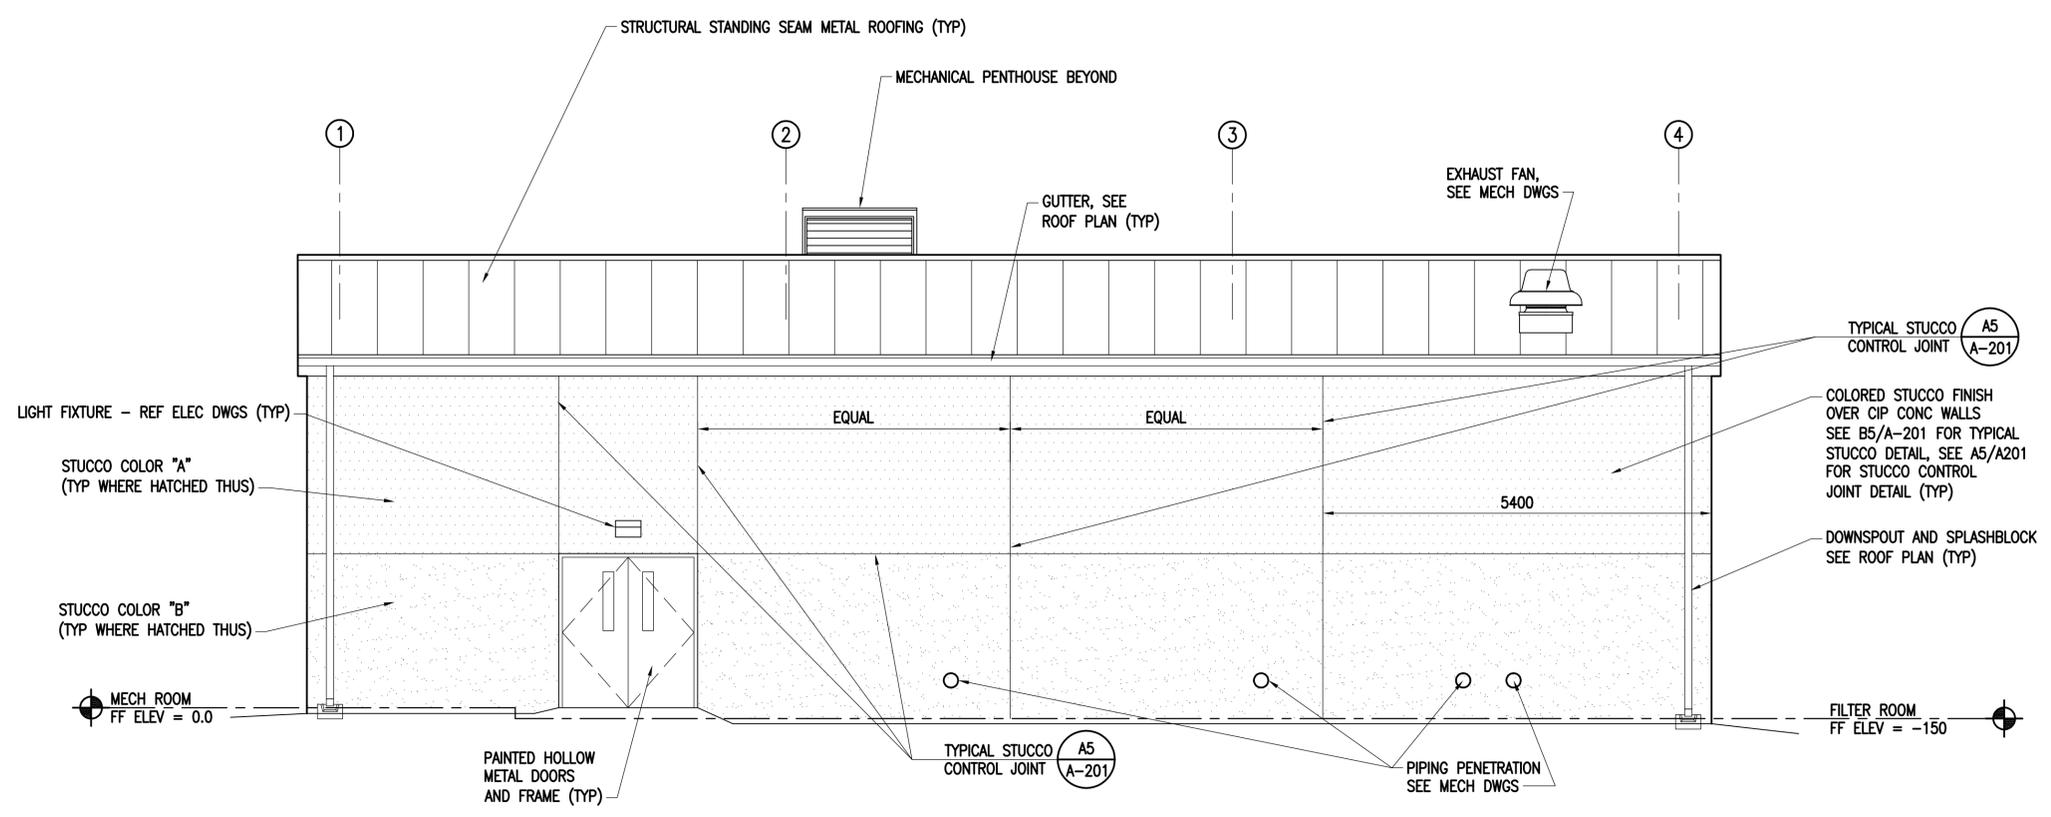

FILTER BUILDING EXTERIOR ELEVATION
SCALE: 1:50
A-103
C2

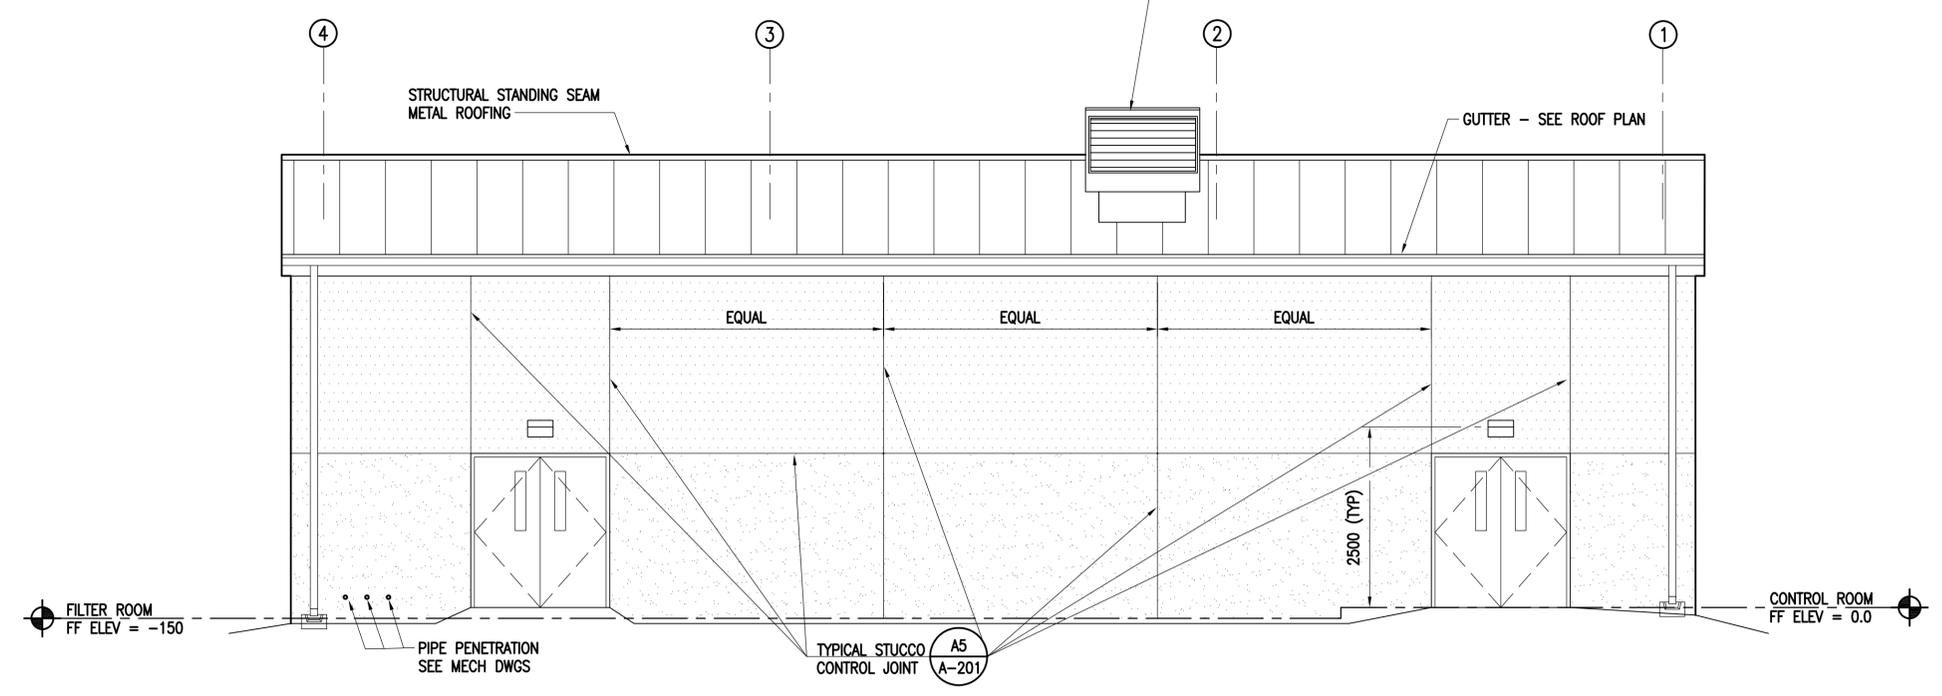

FILTER BUILDING EXTERIOR ELEVATION
SCALE: 1:50
A-103
A2

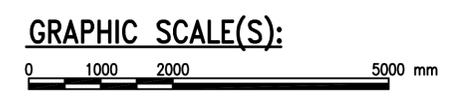

APPR	DATE
SYN	DESCRIPTION
 NAVFAC COMMONWEALTH OF VIRGINIA PAUL W. SHOPE JR. Lic. No. 12110 ARCHITECT	
Austin Brockenbrough ENGINEERING - CONSULTING	
APPROVED	
FOR COMMANDER NAVFAC	
ACTIVITY	
SATISFACTORY TO DATE	
DES	PWS
DRW	JRW
CHK	JTR
BRANCH MANAGER	
CHIEF ENG/ARCH	
<<CR>>	
DEPARTMENT OF THE NAVY NAVAL FACILITIES ENGINEERING COMMAND NAVAL FACILITIES ENGINEERING COMMAND NORFOLK, VIRGINIA DUBOITI AFRICA CAMP LEMONNIER DESC 1701/P-1701 CONSTRUCT FUEL STORAGE FACILITIES FILTER BUILDING ELEVATIONS	
SCALE: AS NOTED	
PROJECT NO.:	
WORK ORDER NO.:	
NAVFAC DRAWING NO. 14047057	
SHEET 93 OF 186	
A-202	
DRAWFORM REVISION: 10 MARCH 2009	


FILE NAME: G:\14 Jobs\14-013 Djibouti - NAVFAC LANT\1404 AutoCAD\A-203 FILTER BUILDING ELEVATIONS.dwg LAYOUT NAME: FILTER BUILDING ELEVATIONS PLOTTED: Friday, March 25, 2016 - 8:38am USER: wherrmann

D


C

B

A

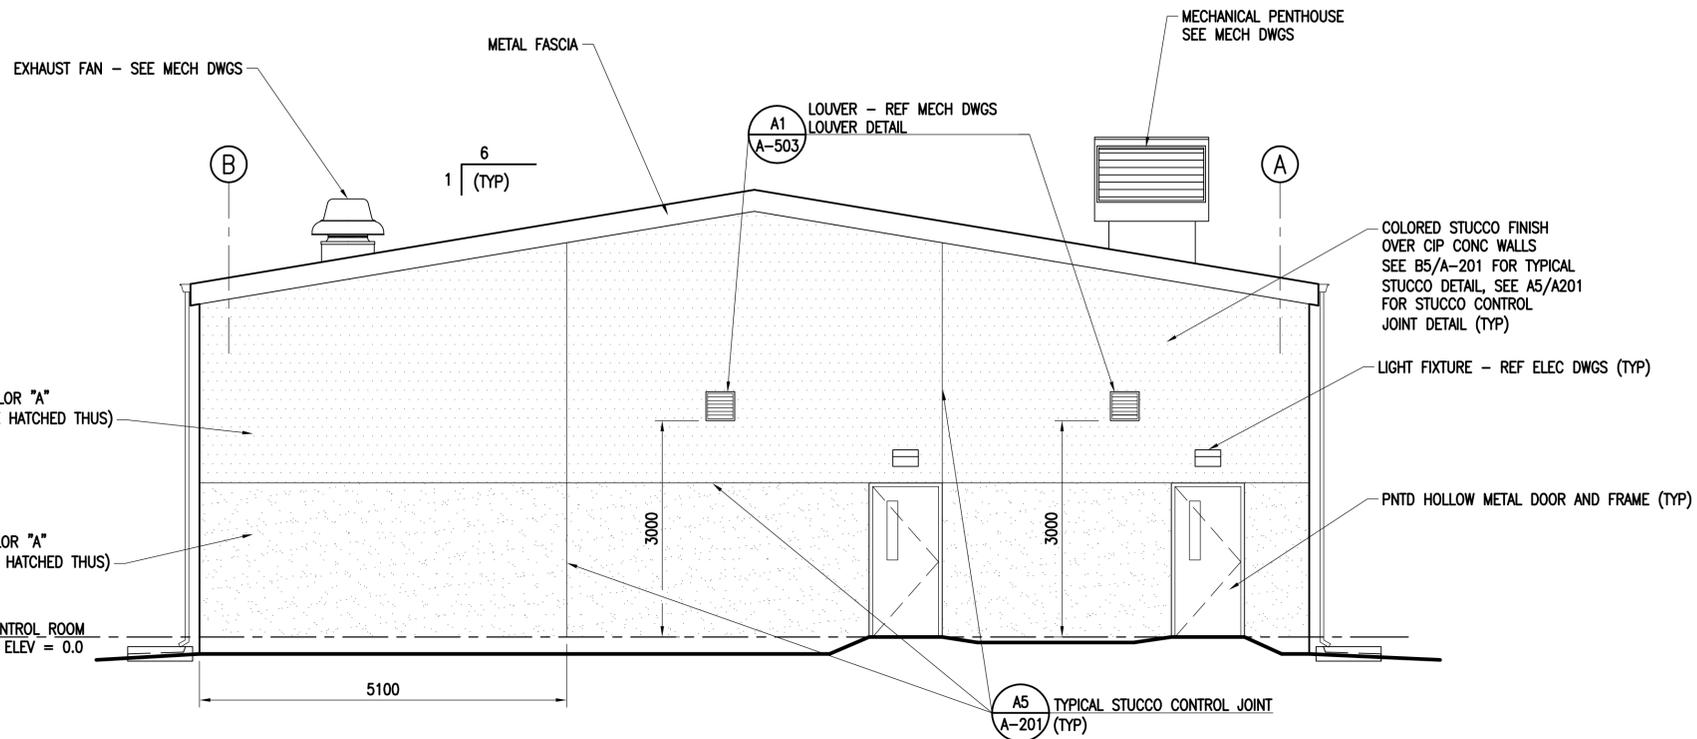


**FILTER BUILDING
EXTERIOR ELEVATION** (C2)
SCALE: 1:50 A-103

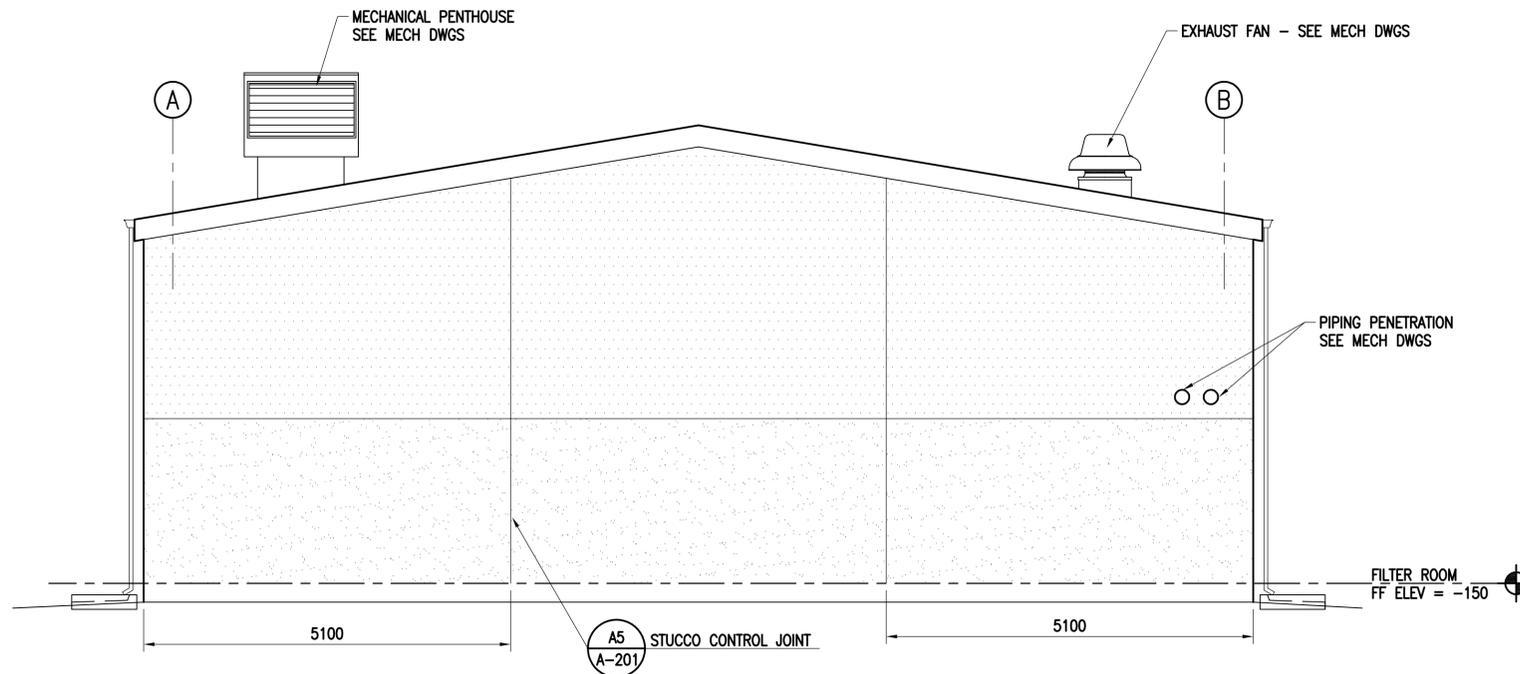

**FILTER BUILDING
EXTERIOR ELEVATION** (A2)
SCALE: 1:50 A-103



SYN	DESCRIPTION	DATE	APPR

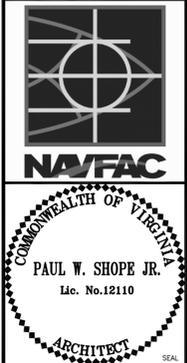



APPROVED	A/E INFO
FOR COMMANDER NAVFAC	ACTIVITY
SATISFACTORY TO	DATE
DES PWS	DRW JRW
CHK JTR	
BRANCH MANAGER	
CHIEF ENG/ARCH	
<<CR>>	

DEPARTMENT OF THE NAVY
ATLANTIC DIVISION
CAMP LEMONNIER
NAVAL FACILITIES ENGINEERING COMMAND
NORFOLK, VIRGINIA
DUBOUTI AFRICA
DESC 1701/P-1701
CONSTRUCT FUEL STORAGE FACILITIES
FILTER BUILDING ELEVATIONS

SCALE:	AS NOTED
PROJECT NO.:	
WORK ORDER NO.:	
NAVFAC DRAWING NO.:	14047058
SHEET	94 OF 186
A-203	


DRAWFORM REVISION: 10 MARCH 2009

FILE NAME: G:\14_jobs\14-013_Dibouti - Fuel Storage Facility - NAVFAC LANT/CDR Aue604\A-204_OPERATIONS BUILDING ELEVATIONS.dwg LAYOUT NAME: OPERATIONS BUILDING ELEVATIONS PLOTTED: Friday, March 25, 2016 - 8:38am USER: whermann

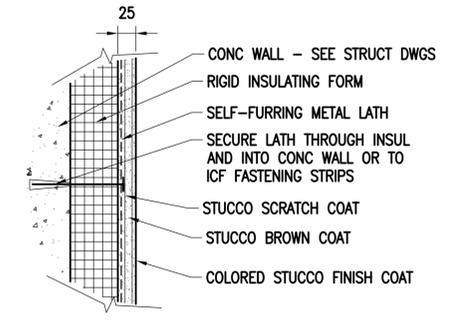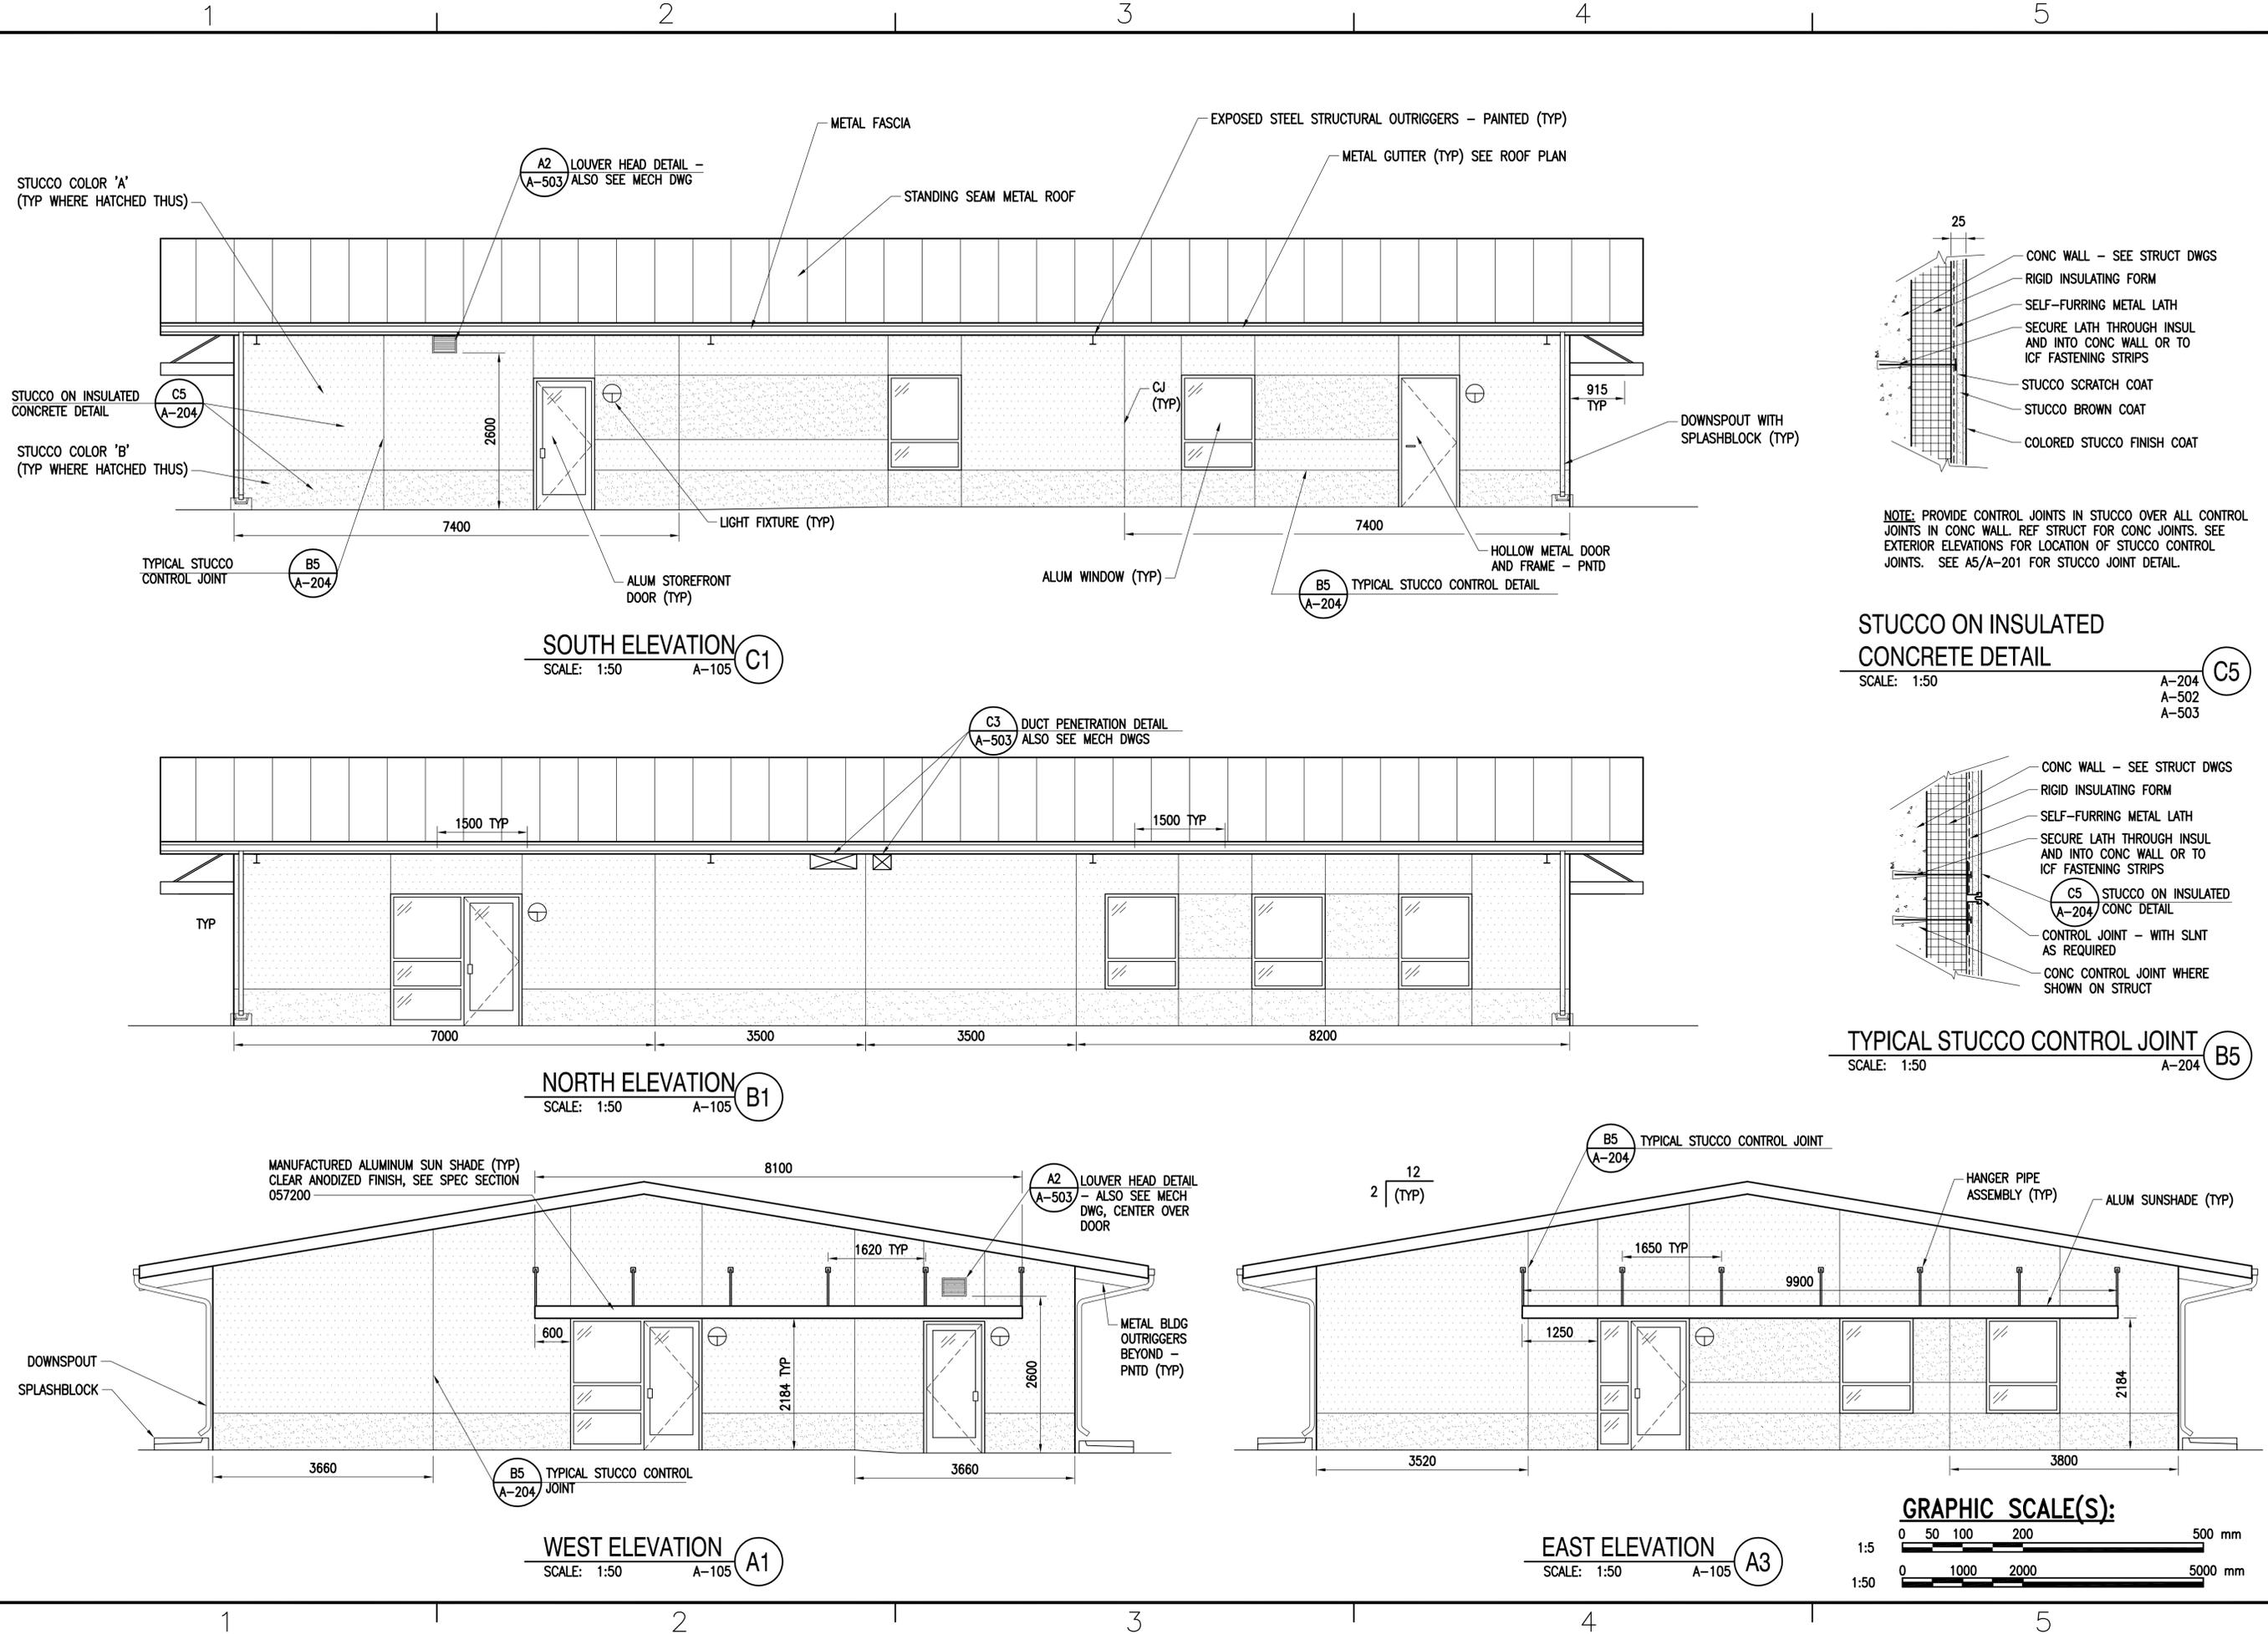


NOTE: PROVIDE CONTROL JOINTS IN STUCCO OVER ALL CONTROL JOINTS IN CONC WALL. REF STRUCT FOR CONC JOINTS. SEE EXTERIOR ELEVATIONS FOR LOCATION OF STUCCO CONTROL JOINTS. SEE A5/A-201 FOR STUCCO JOINT DETAIL.


STUCCO ON INSULATED CONCRETE DETAIL
SCALE: 1:50
A-204
A-502
A-503

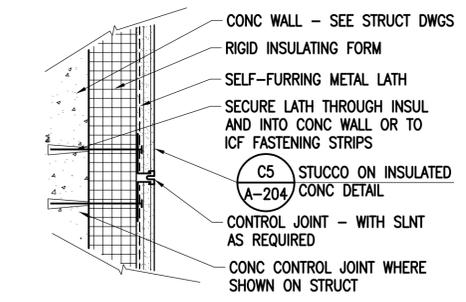


TYPICAL STUCCO CONTROL JOINT
SCALE: 1:50
A-204

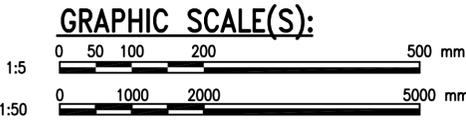


APPR	
DATE	
SYN	
DESCRIPTION	
PAUL W. SHOPE JR. Lic. No. 12110 ARCHITECT	
APPROVED	A/E INFO
FOR COMMANDER NAVFAC	ACTIVITY
SATISFACTORY TO	DATE
DES: PWS	DRW: JRW
CHK: JTR	
BRANCH MANAGER	
CHIEF ENG/ARCH	
DEPARTMENT OF THE NAVY NAVAL FACILITIES ENGINEERING COMMAND ATLANTIC DIVISION CAMP LEMONIER NAVFAC LANT/CDR Aue604\A-204_OPERATIONS BUILDING ELEVATIONS.dwg	
DESC 1701/P-1701 CONSTRUCT FUEL STORAGE FACILITIES OPERATIONS BUILDING ELEVATIONS	
SCALE:	AS NOTED
PROJECT NO.:	
WORK ORDER NO.:	
NAVFAC DRAWING NO.:	14047059
SHEET	95 OF 186
A-204	
<small>DRAWING REVISION: 10 MARCH 2009</small>	

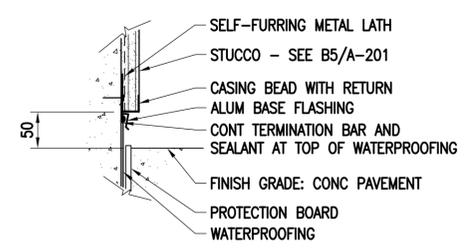


DETAIL
SCALE: 1:5
A-301 **D1**

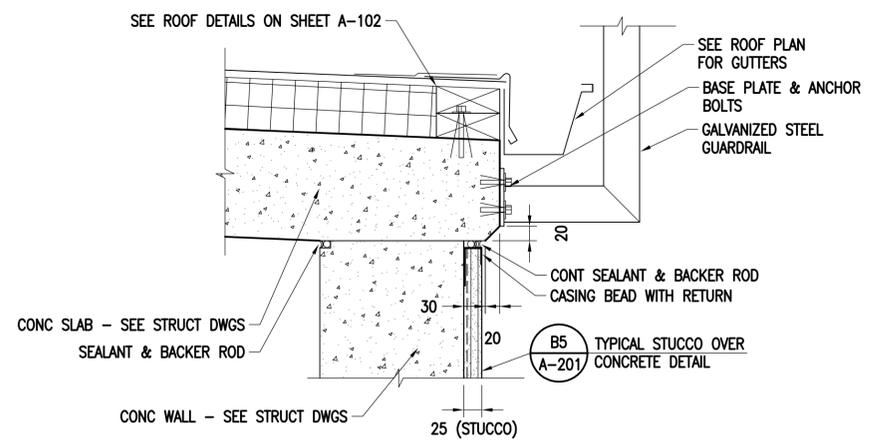


DETAIL
SCALE: 1:5
A-301 **B5**

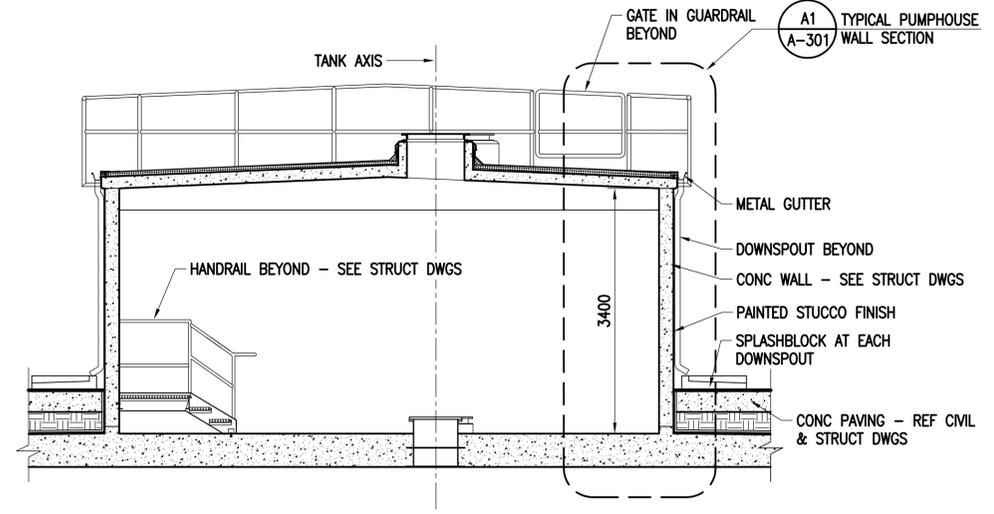


SECTION
SCALE: 1:50
A-101 **A1**

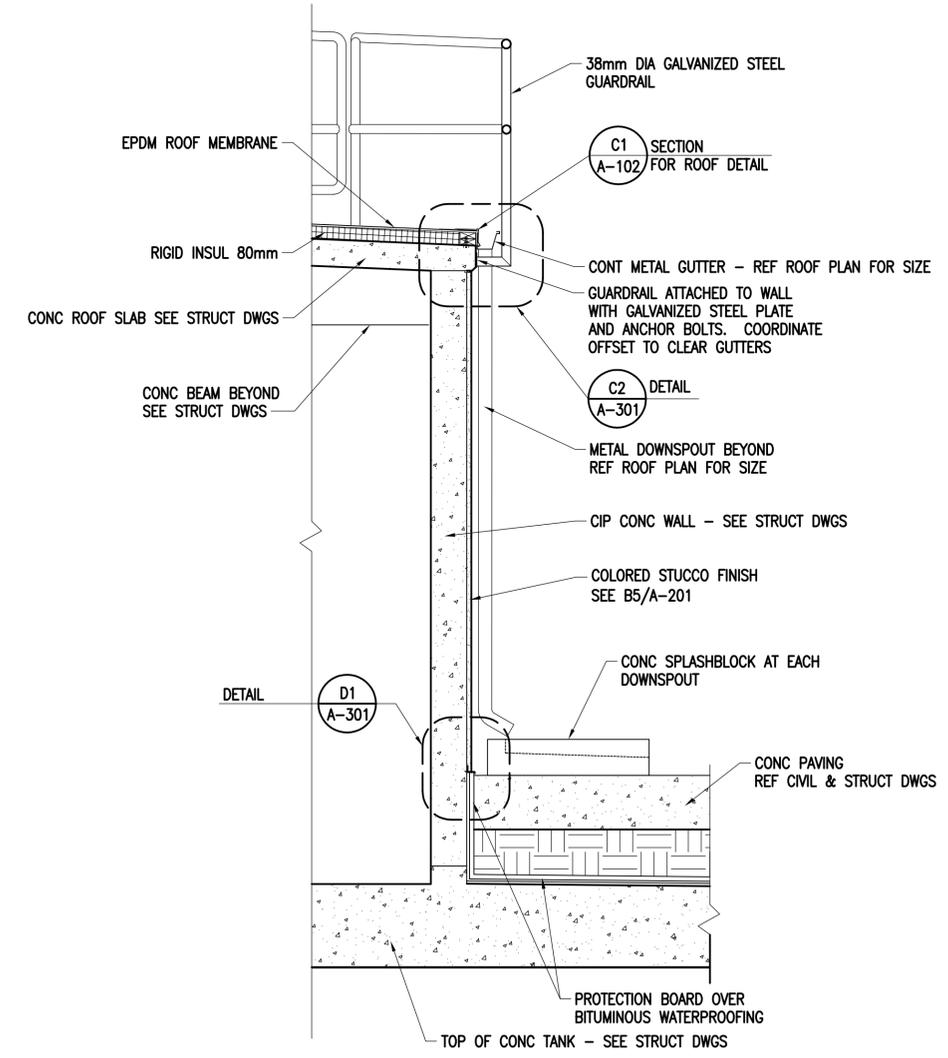

TYPICAL PUMPHOUSE WALL SECTION
SCALE: 1:20
A-301 **A1**

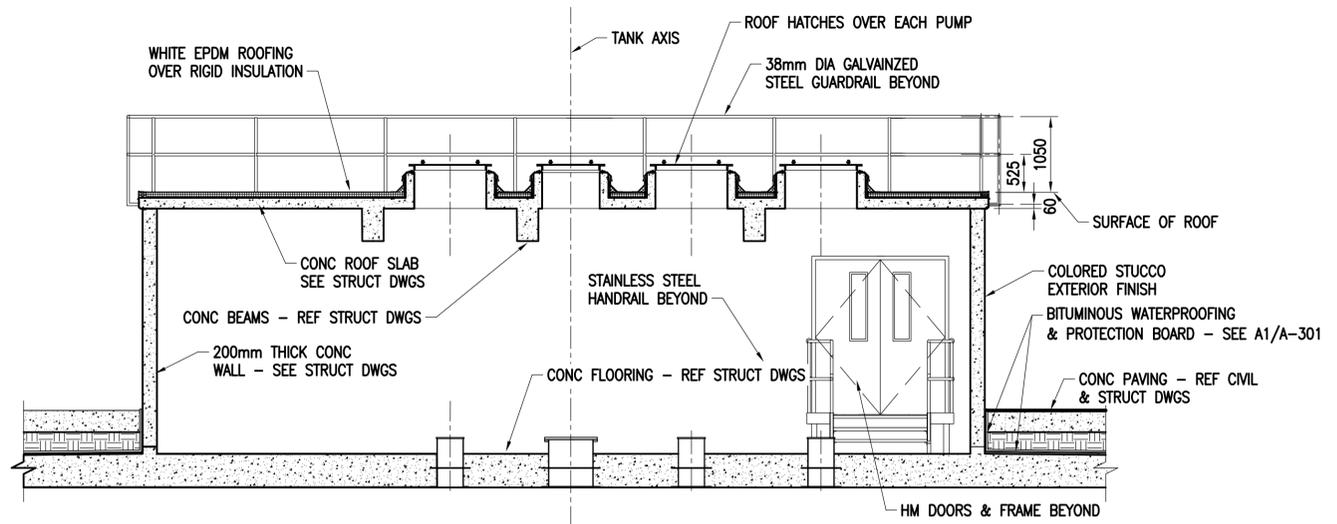


SECTION
SCALE: 1:50
A-101 **A3**

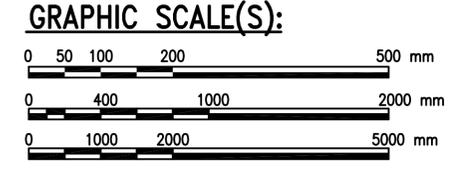

APPR	DATE
SYN	DESCRIPTION
 NAVFAC COMMONWEALTH OF VIRGINIA PAUL W. SHOPE JR. Lic. No. 12110 ARCHITECT	
Austin Brockenbrough ENGINEERING - CONSULTING	
APPROVED	A/E INFO
FOR COMMANDER NAVFAC	ACTIVITY
SATISFACTORY TO	DATE
DESIGNED BY PWS	DRAWN BY JRW CHECKED BY JTR
BRANCH MANAGER	CHIEF ENG/ARCH
NAVAL FACILITIES ENGINEERING COMMAND NAVAL FACILITIES ENGINEERING COMMAND NORFOLK, VIRGINIA DUBOULT AFRICA CAMP LEMONNIER DESC 1701/P-1701 CONSTRUCT FUEL STORAGE FACILITIES PUMPHOUSE SECTIONS	
SCALE:	AS NOTED
PROJECT NO.:	
WORK ORDER NO.:	
NAVFAC DRAWING NO.:	14047060
SHEET	96 OF 186
A-301	
DRAWING REVISION: 10 MARCH 2009	

FILE NAME: G:\14 Jobs\14-013 Djbouti - Fuel Storage Facility - NAVFAC LANTCOM AutoCAD\VA-301 PUMPHOUSE SECTIONS.dwg LAYOUT NAME: PUMPHOUSE SECTIONS PLOTTED: Friday, March 25, 2016 - 8:39am USER: wherrmann


FILE NAME: G:\14 Jobs\14-013 Djibouti - Fuel Storage Facility - NAVFAC LANT\14047061\A-302 FILTER BUILDING SECTIONS.dwg LAYOUT NAME: FILTER BUILDING SECTIONS PLOTTED: Friday, March 25, 2016 - 8:40am USER: whermann

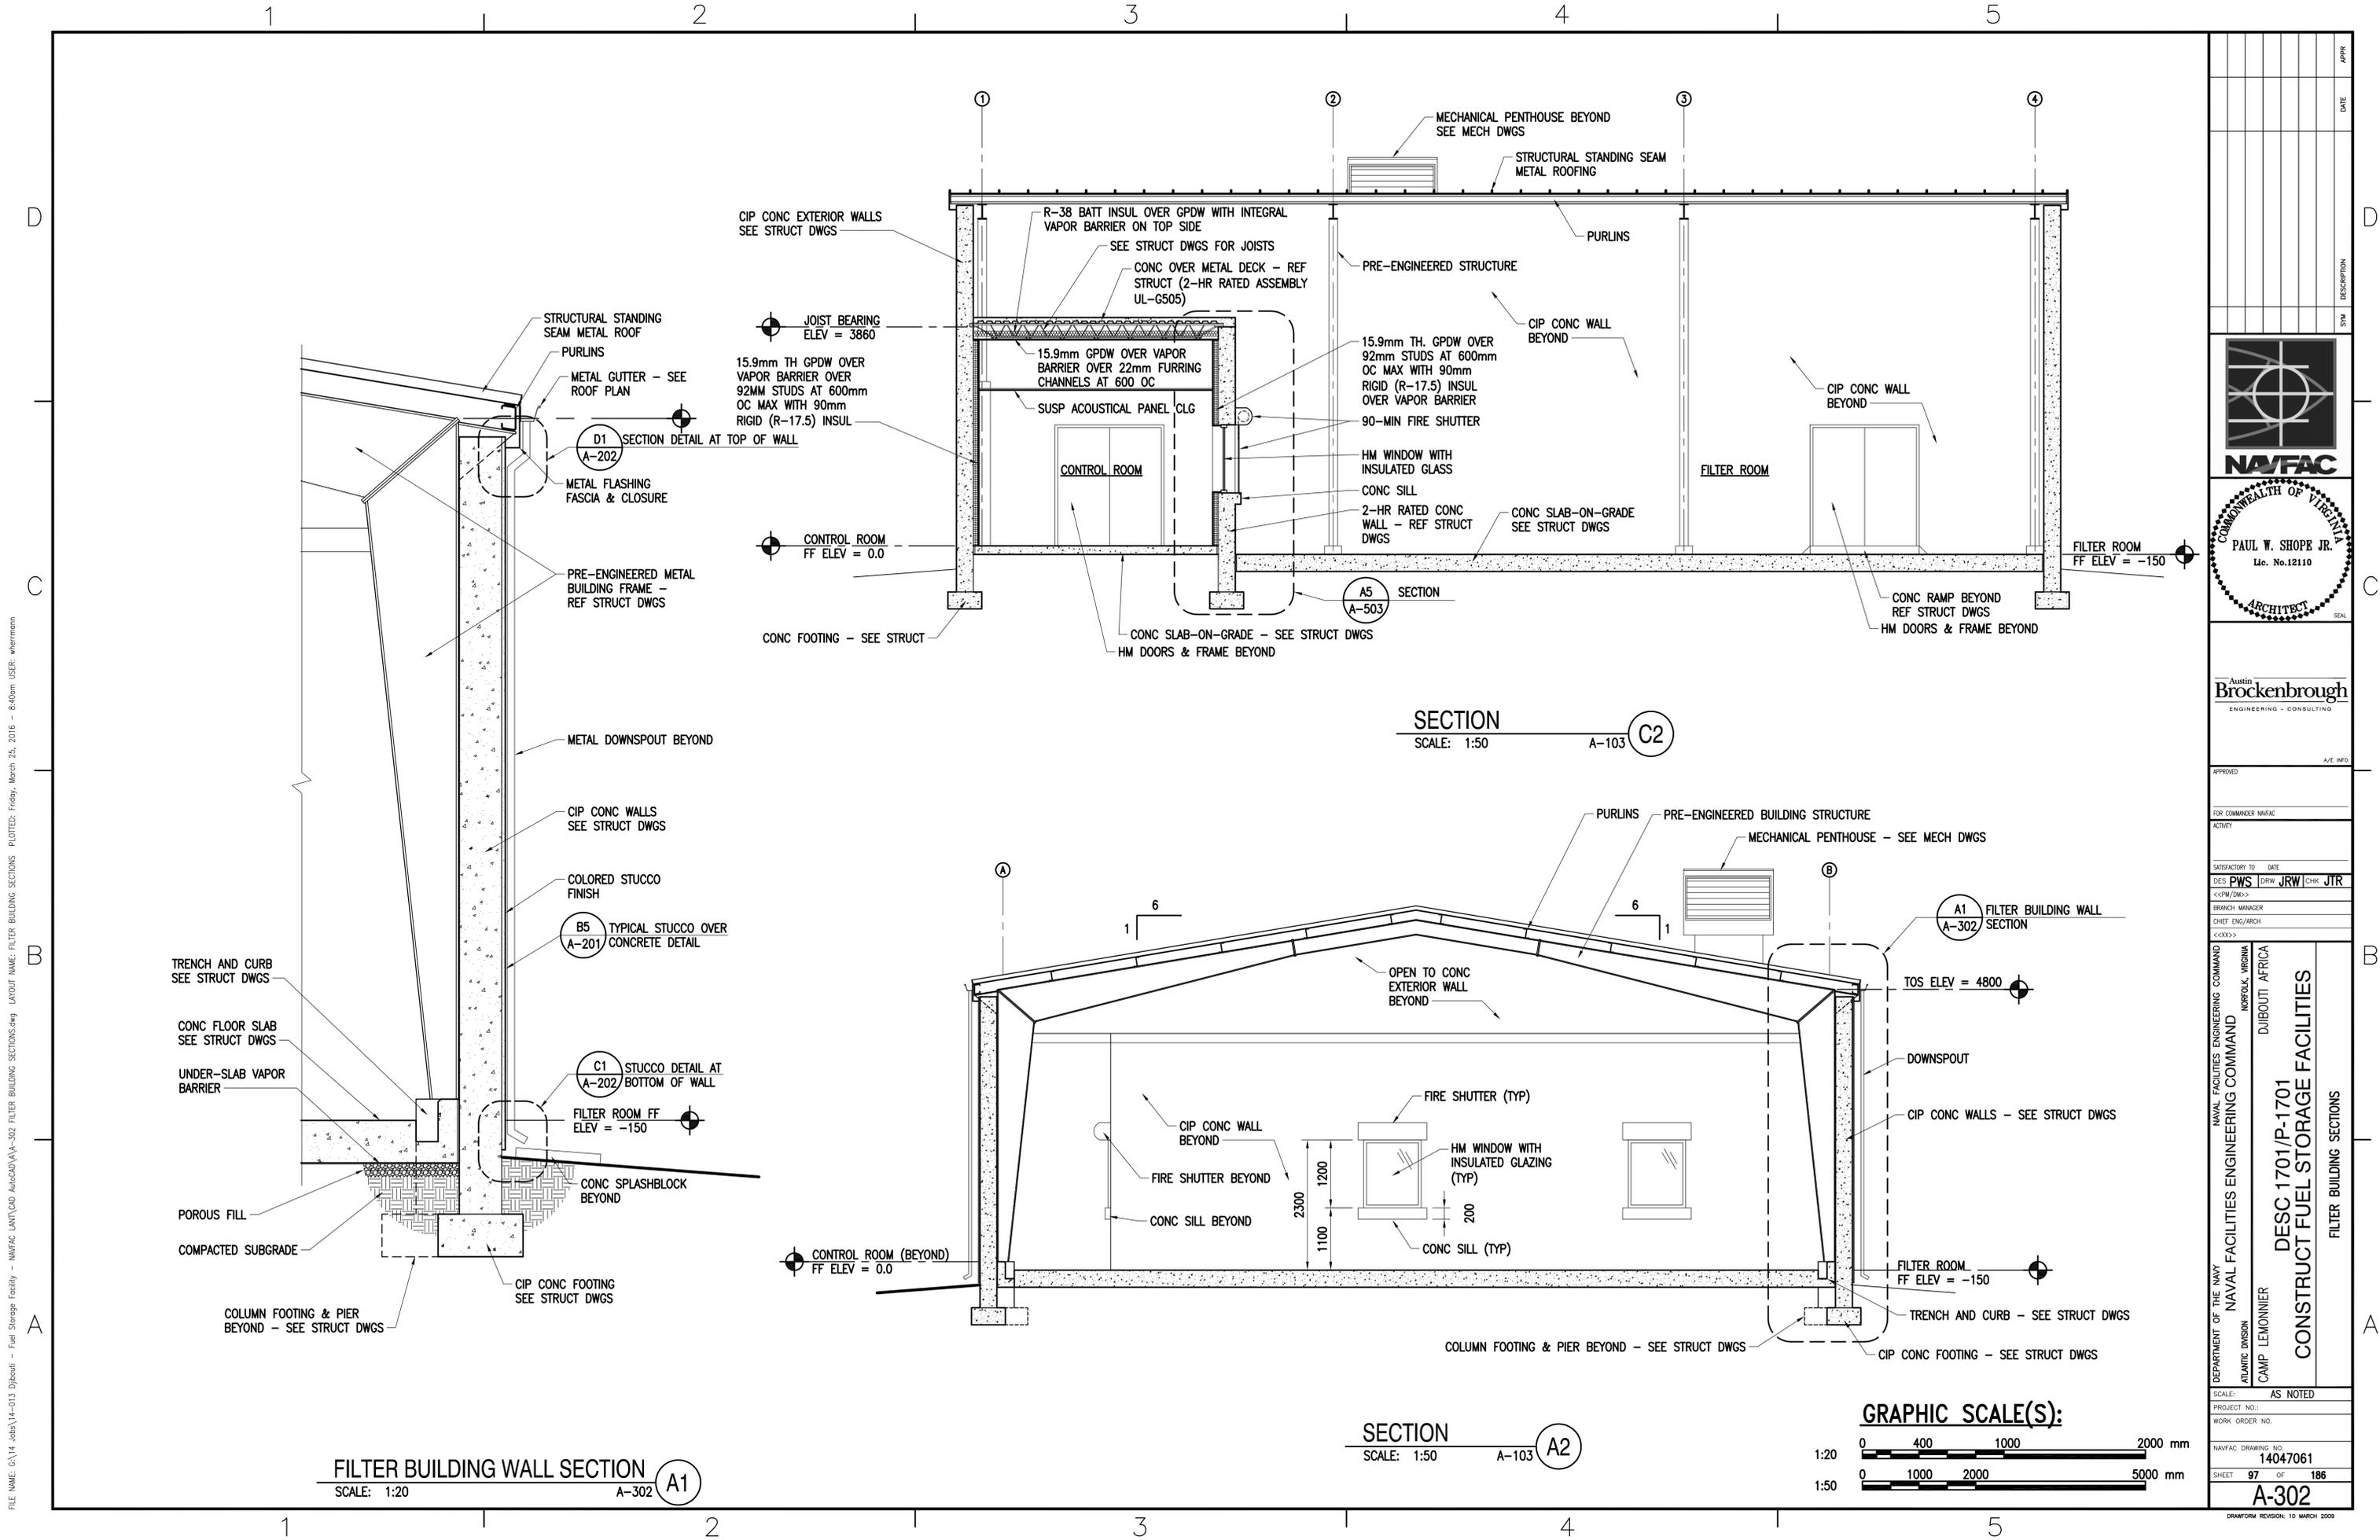

FILTER BUILDING WALL SECTION
SCALE: 1:20 A-302 (A1)


SECTION
SCALE: 1:50 A-103 (A2)

SECTION
SCALE: 1:50 A-103 (C2)

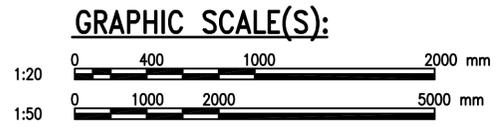

APPROVED	DATE	APP'R
SYN	DESCRIPTION	
 NAVFAC COMMONWEALTH OF VIRGINIA PAUL W. SHOPE JR. Lic. No. 12110 ARCHITECT		
Austin Brockenbrough ENGINEERING - CONSULTING		
APPROVED	A/E INFO	
FOR COMMANDER NAVFAC		
ACTIVITY		
SATISFACTORY TO	DATE	
DES PWS	DRW JRW	CHK JTR
<<PM/DM>>		
BRANCH MANAGER		
CHIEF ENG/ARCH		
<<CR>>		
NAVAL FACILITIES ENGINEERING COMMAND NAVAL FACILITIES ENGINEERING COMMAND NORFOLK, VIRGINIA DUBOULT AFRICA CAMP LEMONNIER		
DESC 1701/P-1701 CONSTRUCT FUEL STORAGE FACILITIES FILTER BUILDING SECTIONS		
SCALE:	AS NOTED	
PROJECT NO.:	14047061	
WORK ORDER NO.:		
NAVFAC DRAWING NO.:	14047061	
SHEET	97	OF 186
A-302		
DRAWING REVISION: 10 MARCH 2009		


FILE NAME: G:\14 Jobs\14-013 D:\b\out - Fuel Storage Facility - NAVFAC LANT/CAD AutoCAD\VA-303 OPERATIONS BUILDING SECTIONS.dwg LAYOUT NAME: OPERATIONS BUILDING SECTIONS PLOTTED: Friday, March 25, 2016 - 8:40am USER: wherrmann

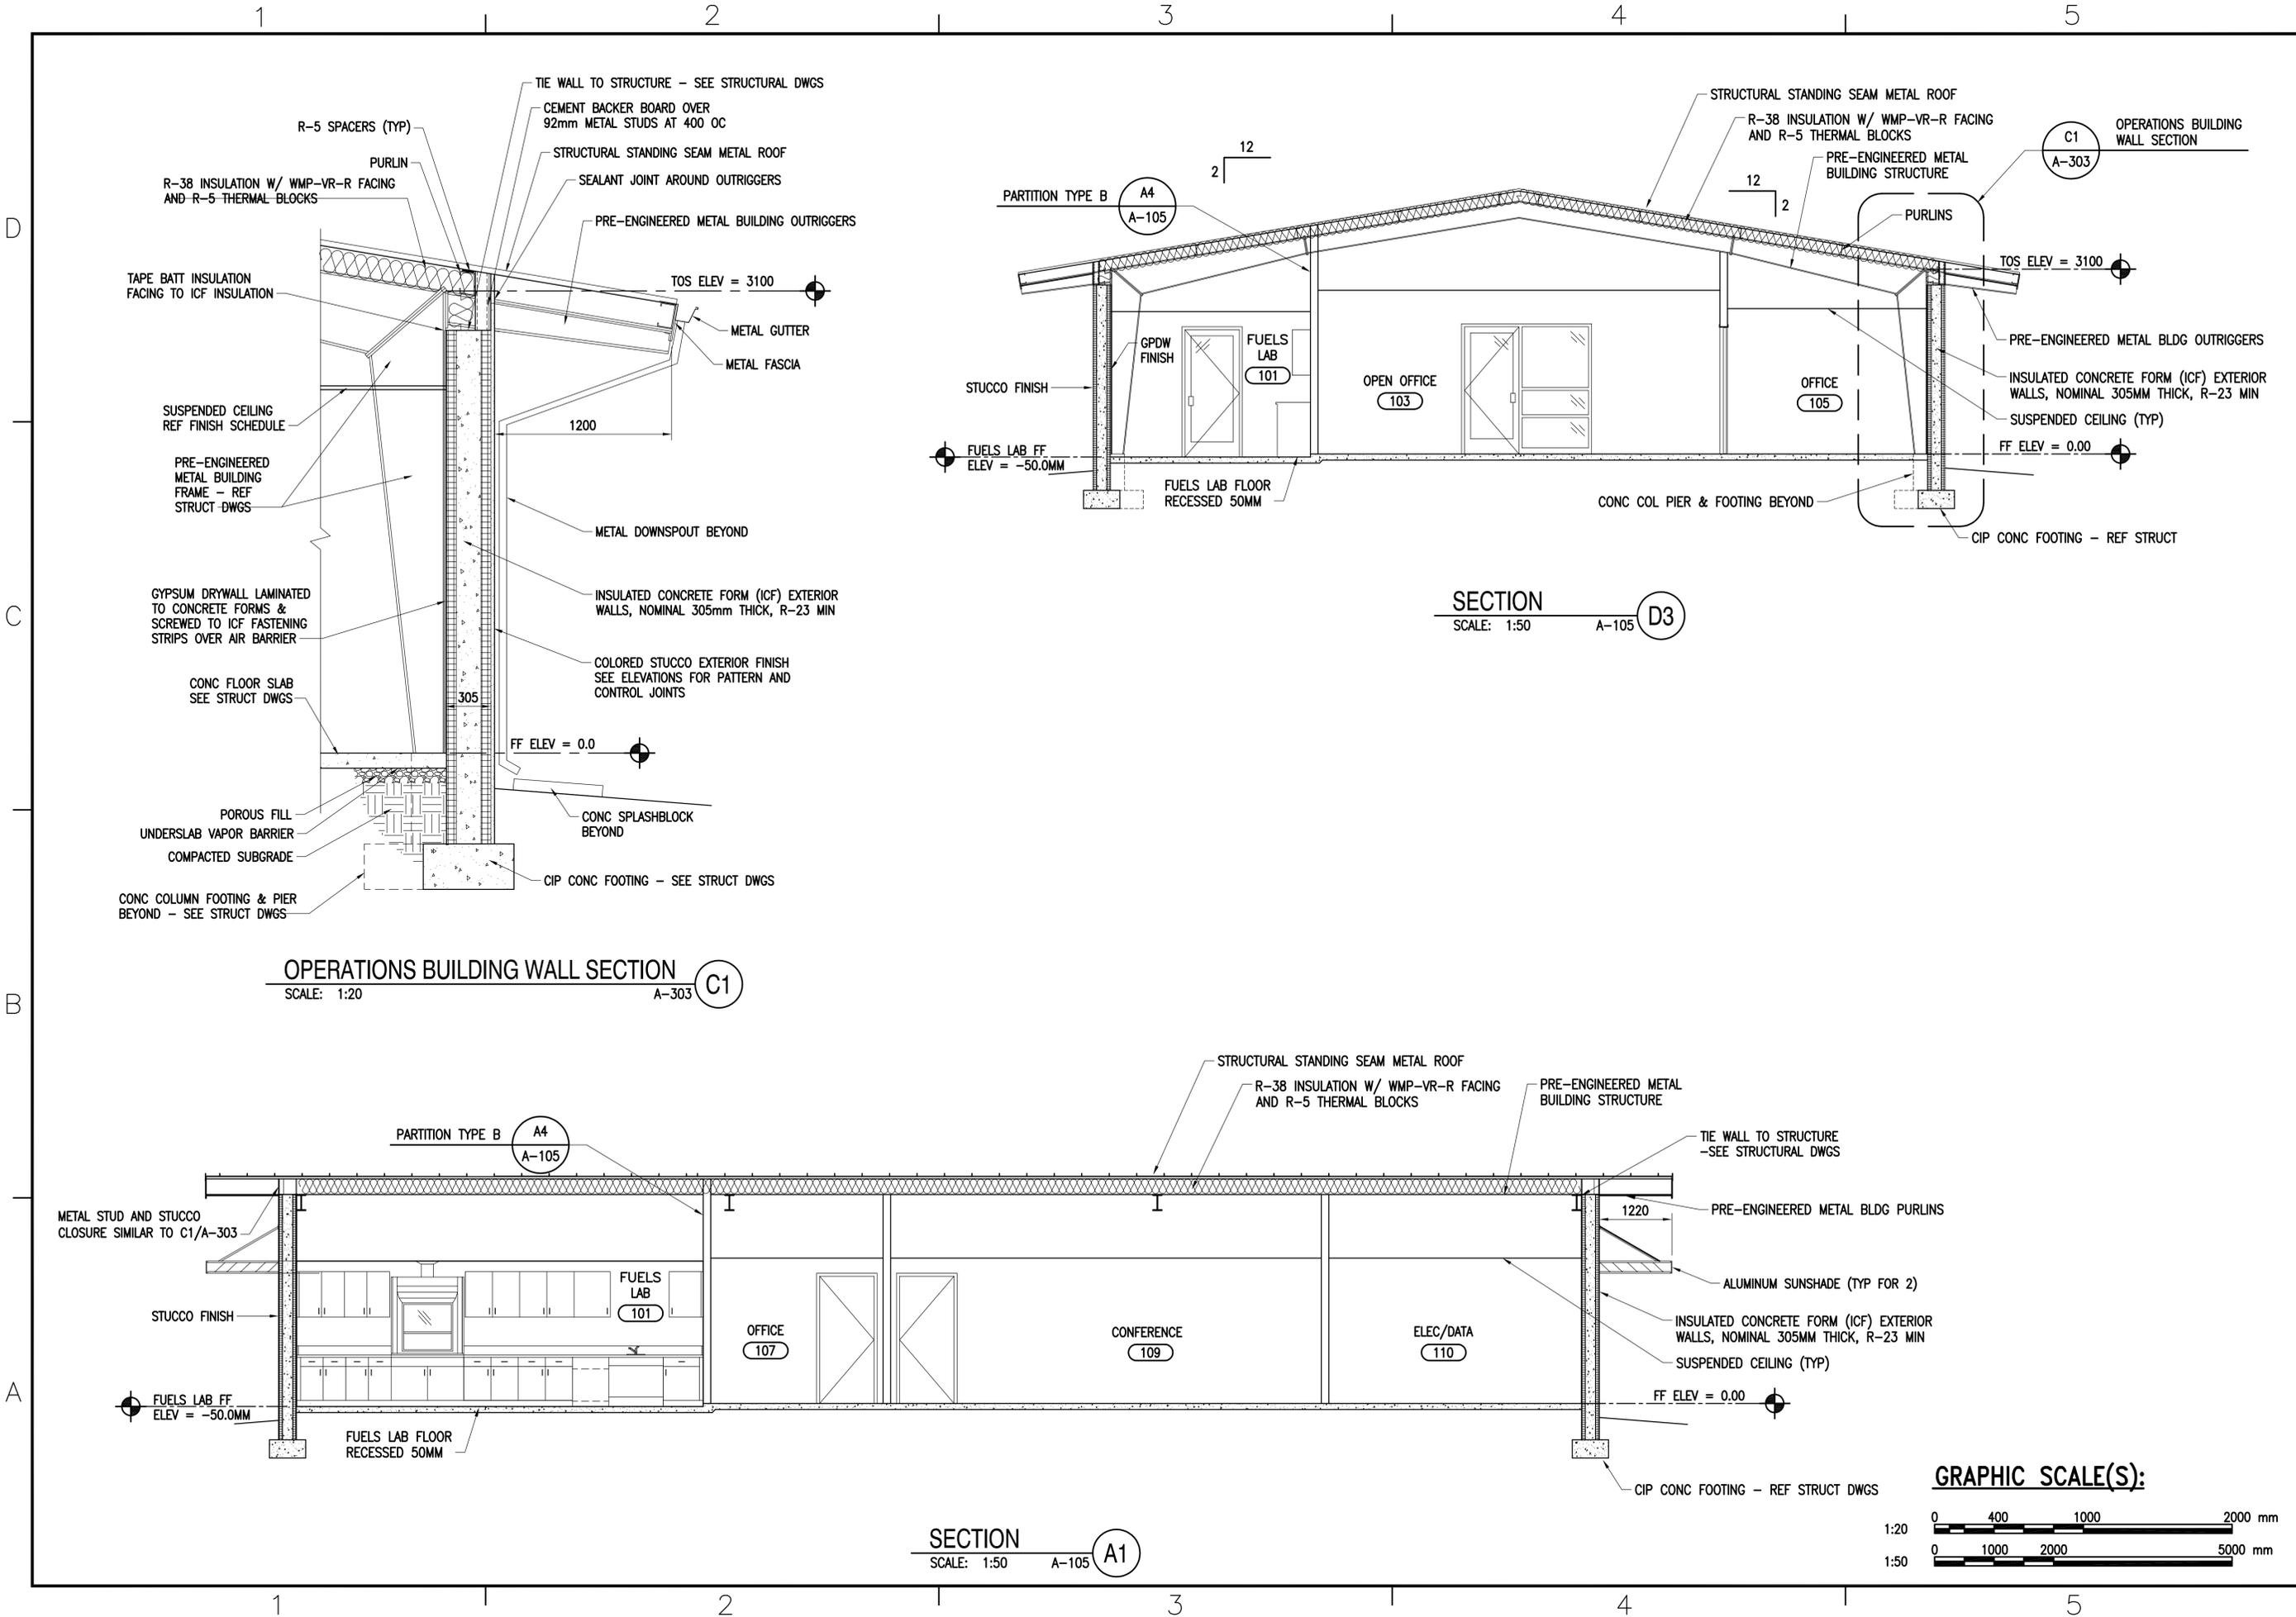

OPERATIONS BUILDING WALL SECTION
SCALE: 1:20 A-303 C1


SECTION
SCALE: 1:50 A-105 D3

SECTION
SCALE: 1:50 A-105 A1

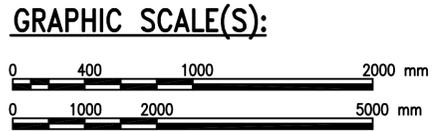

APPR	DATE
SYN	DESCRIPTION
Paul W. Shope Jr. Lic. No. 12110 ARCHITECT	
APPROVED	A/E INFO
FOR COMMANDER NAVFAC	ACTIVITY
SATISFACTORY TO	DATE
DES PWS	DRW JRW
BRANCH MANAGER	CHIEF ENG/ARCH
NAVAL FACILITIES ENGINEERING COMMAND NAVAL FACILITIES ENGINEERING COMMAND NORFOLK, VIRGINIA DUBOITI AFRICA DESC 1701/P-1701 CONSTRUCT FUEL STORAGE FACILITIES OPERATIONS BUILDING SECTIONS	
SCALE:	AS NOTED
PROJECT NO.:	
WORK ORDER NO.	
NAVFAC DRAWING NO.	14047062
SHEET	98 OF 186
A-303	
<small>DRAWFORM REVISION: 10 MARCH 2009</small>	


FILE NAME: G:\14 Jobs\14-013 Dibuair - Fuel Storage Facility - NAVFAC LANT/CAD AutoCAD\VA-501 OPERATIONS BUILDING CASEWORK DETAILS.dwg LAYOUT NAME: OPERATIONS BUILDING CASEWORK DETAILS PLOTTED: Friday, March 25, 2016 - 8:40am USER: wherrmann

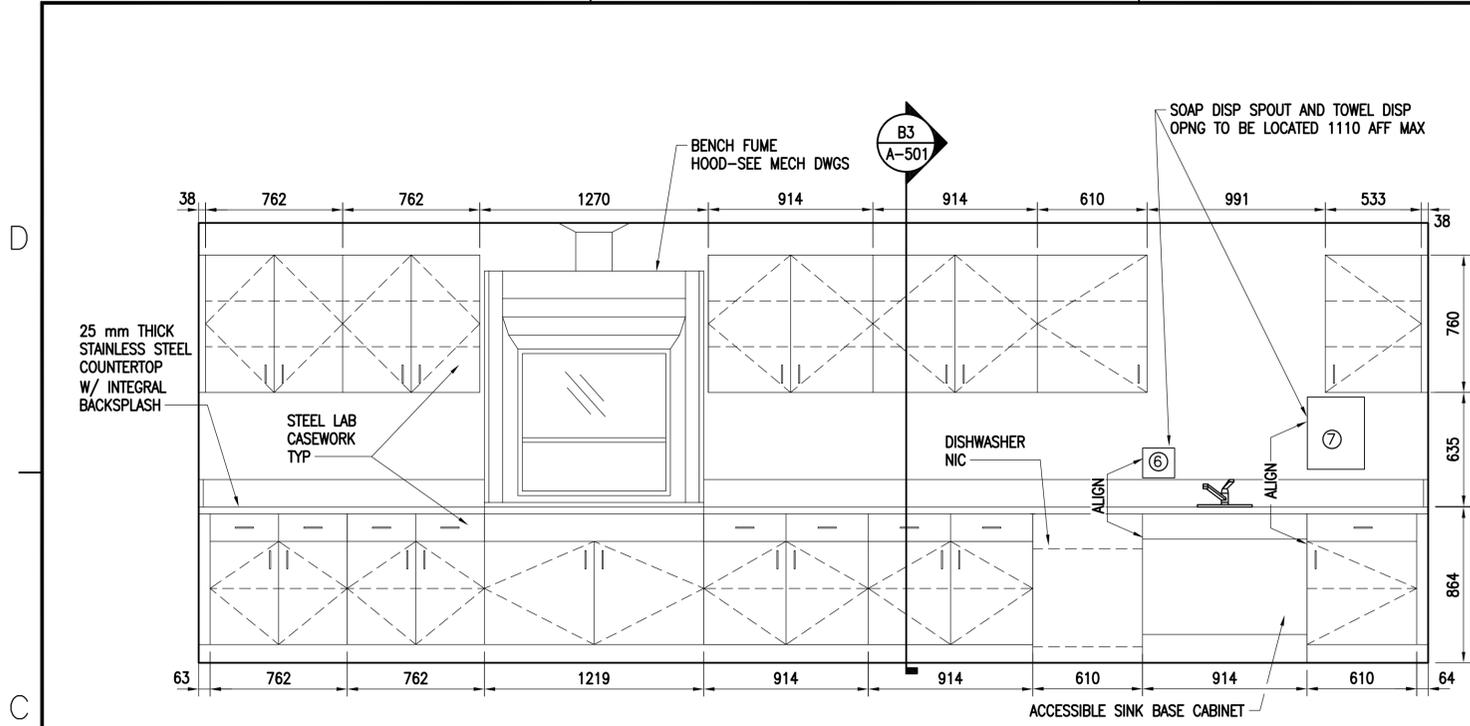

FUELS LAB 101 CASEWORK ELEVATION

SCALE: 1:20


A-105 D1

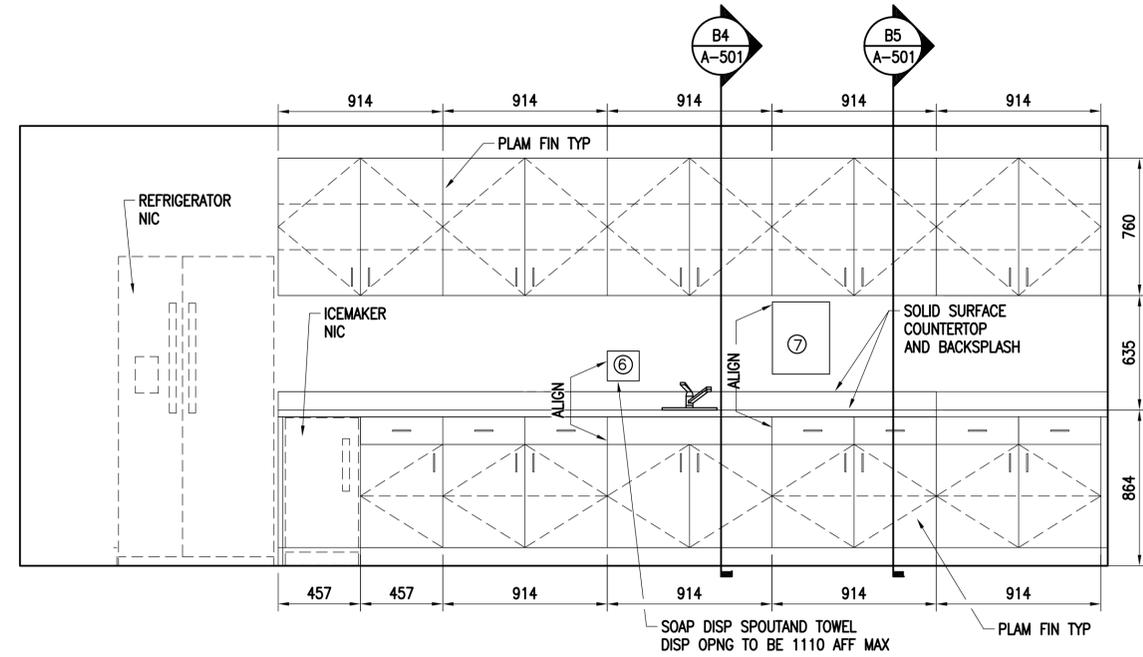

BREAK ROOM 115 CASEWORK ELEVATION

SCALE: 1:20


A-105 A-108 D4

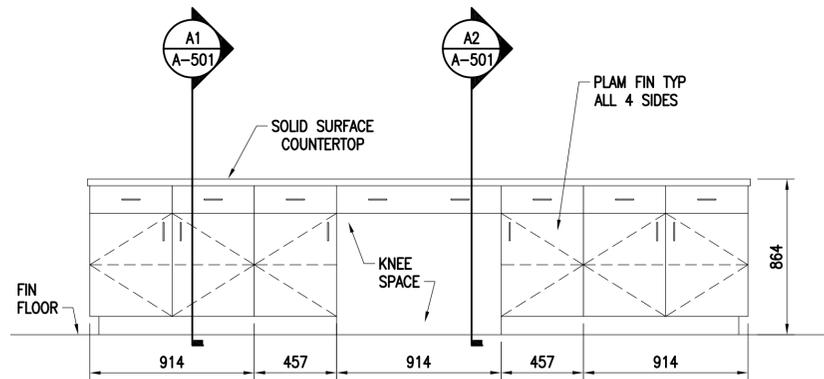

OPEN OFFICE 103 CASEWORK ELEVATION


SCALE: 1:20

A-105 B1

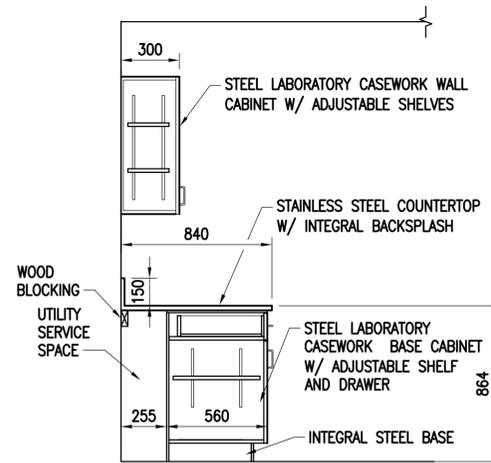


SECTION B3

SCALE: 1:20 A-501

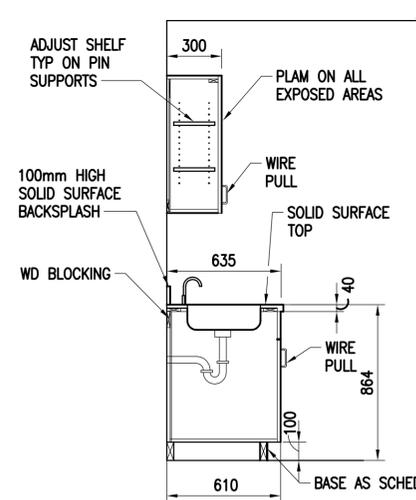


SECTION B4

SCALE: 1:20 A-501

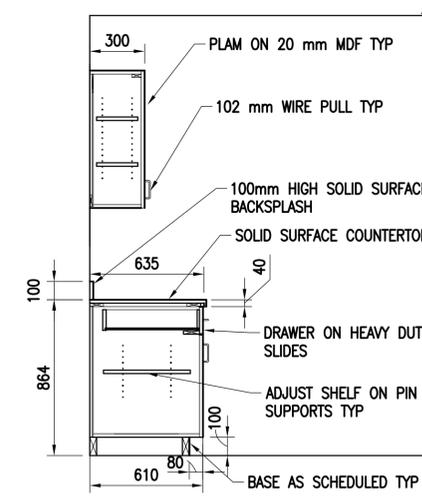


SECTION B5

SCALE: 1:20 A-501

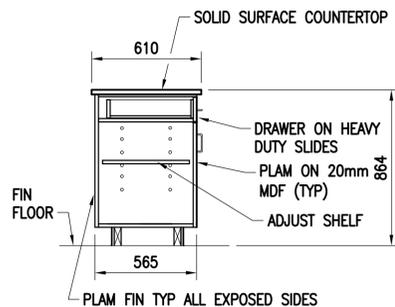

SECTION A1


SCALE: 1:20 A-501

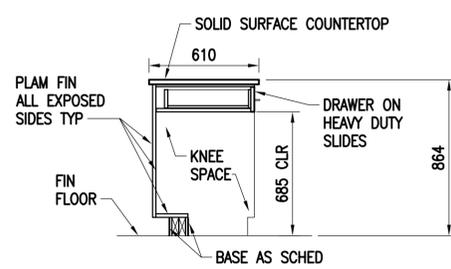

SECTION A2


SCALE: 1:20 A-501

GRAPHIC SCALE(S):

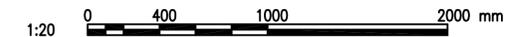


APPR	
DATE	
SYN	DESCRIPTION
PAUL W. SHOPE JR. Lic. No. 12110 ARCHITECT	
APPROVED FOR COMMANDER NAVFAC ACTIVITY SATISFACTORY TO DATE DES: JRW DRW: JRW CHK: PWS BRANCH MANAGER CHIEF ENG/ARCH <<CR>>	
DEPARTMENT OF THE NAVY ATLANTIC DIVISION CAMP LEMONIER NAVAL FACILITIES ENGINEERING COMMAND NAVAL FACILITIES ENGINEERING COMMAND NORFOLK, VIRGINIA DUBOITI AFRICA	DESC 1701/P-1701 CONSTRUCT FUEL STORAGE FACILITIES OPERATIONS BUILDING CASEWORK DETAILS
SCALE: AS NOTED PROJECT NO.: WORK ORDER NO.: NAVFAC DRAWING NO.: 14047063 SHEET 99 OF 186 A-501 <small>DRAWFORM REVISION: 10 MARCH 2009</small>	


FILE NAME: G:\14 Jobs\14-013 Djibouti - Fuel Storage Facility - NAVFAC LANT/CAD AutoCAD\VA-502 DOOR DETAILS.dwg LAYOUT NAME: DOOR DETAILS PLOTTED: Friday, March 25, 2016 - 8:40am USER: whiermann

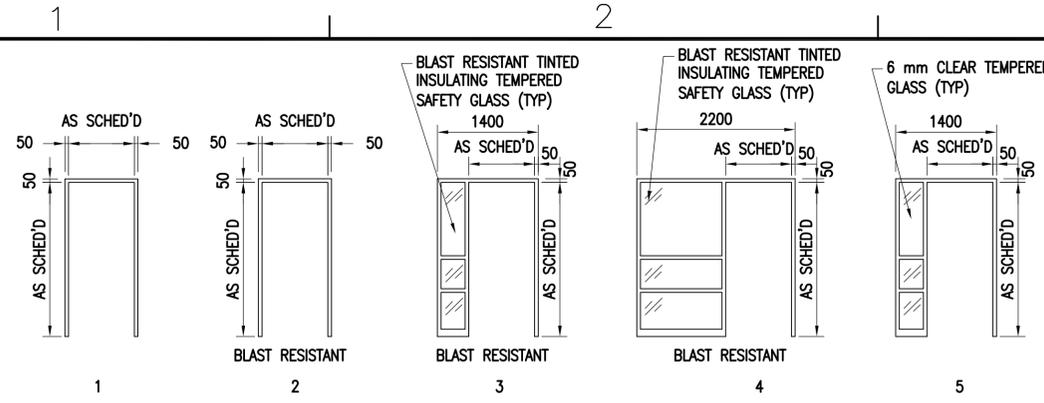


FRAME TYPES
SCALE: 1:50 A-601 (D1)

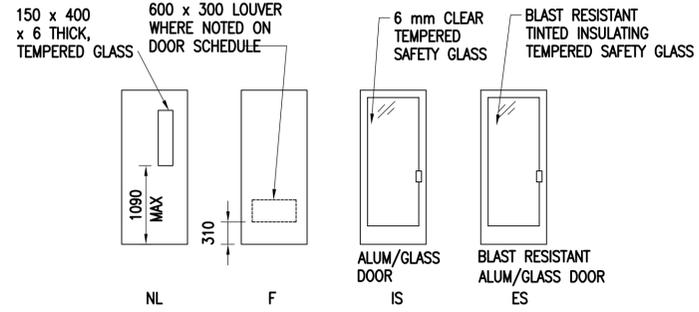


DOOR TYPES
SCALE: 1:50 A-601 (C1)

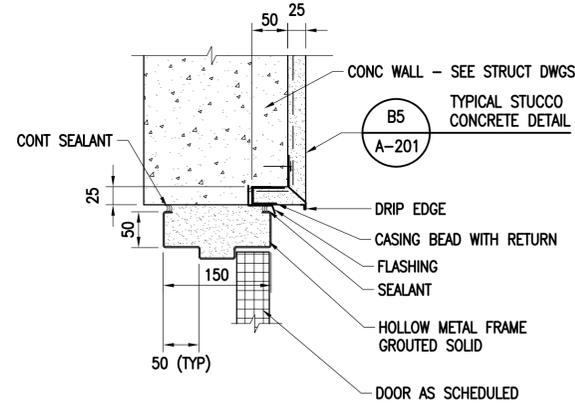


DOOR HEAD DETAIL
SCALE: 1:5 A-601 (B1)

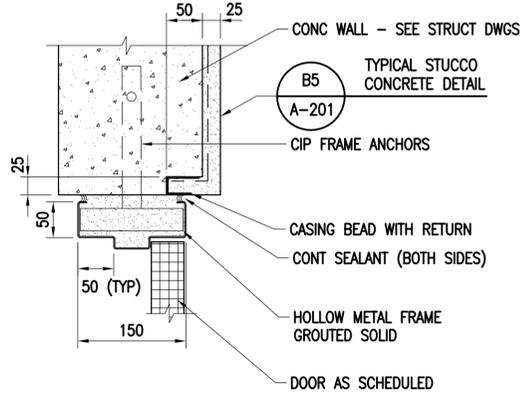


DOOR JAMB DETAIL
SCALE: 1:5 A-601 (A1)

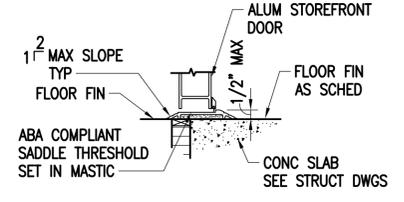


THRESHOLD DETAIL
SCALE: 1:5 A-601 (C2)

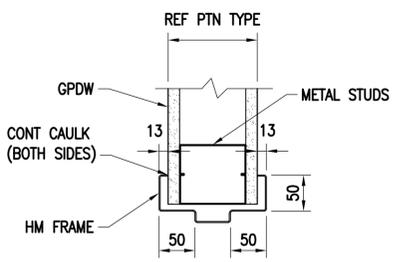


DOOR HEAD/JAMB DETAIL
SCALE: 1:5 A-601 (B2)

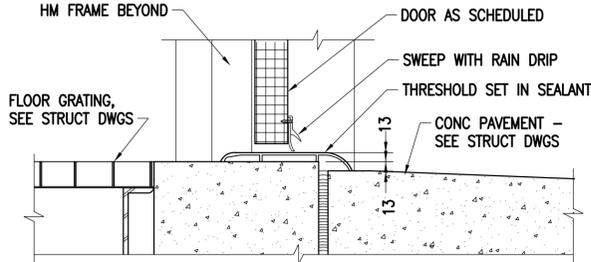


THRESHOLD DETAIL
SCALE: 1:5 A-601 (A2)

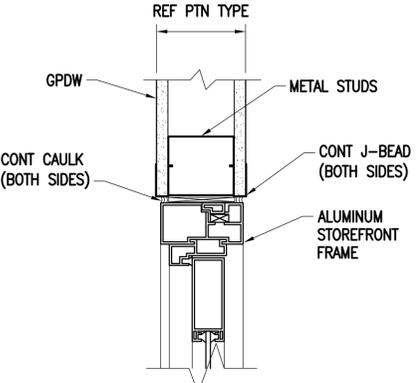


STOREFRONT HEAD/JAMB DETAIL
SCALE: 1:5 A-601 (C3)

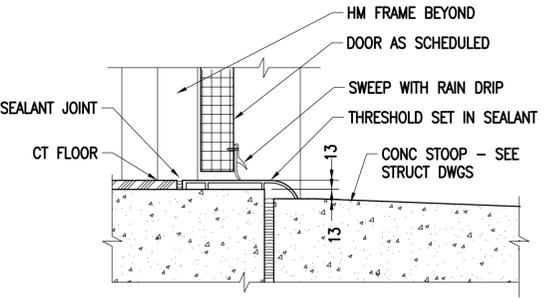


THRESHOLD DETAIL
SCALE: 1:5 A-601 (B3)

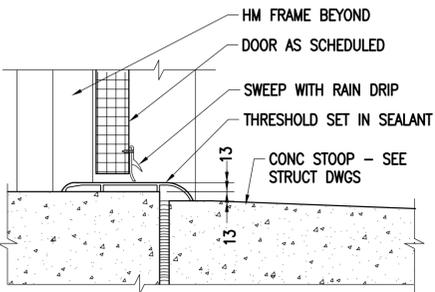


THRESHOLD DETAIL
SCALE: 1:5 A-601 (A3)

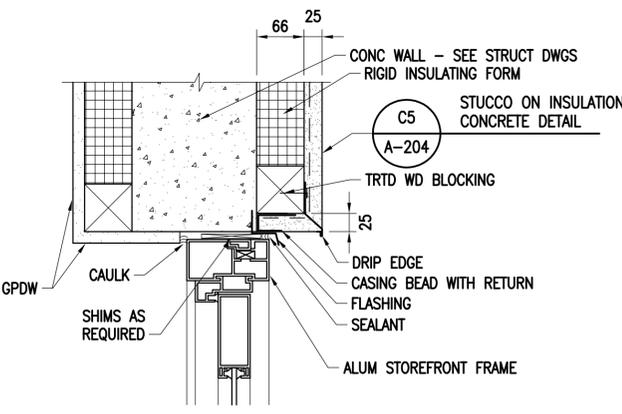


STOREFRONT DOOR HEAD DETAIL
SCALE: 1:5 A-601 (D4)

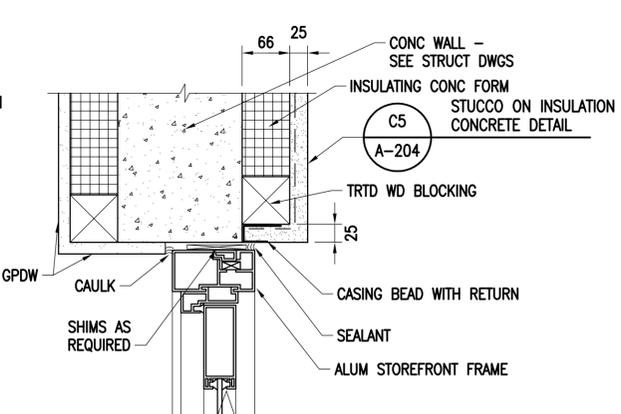


STOREFRONT DOOR JAMB DETAIL
SCALE: 1:5 A-601 (D5)

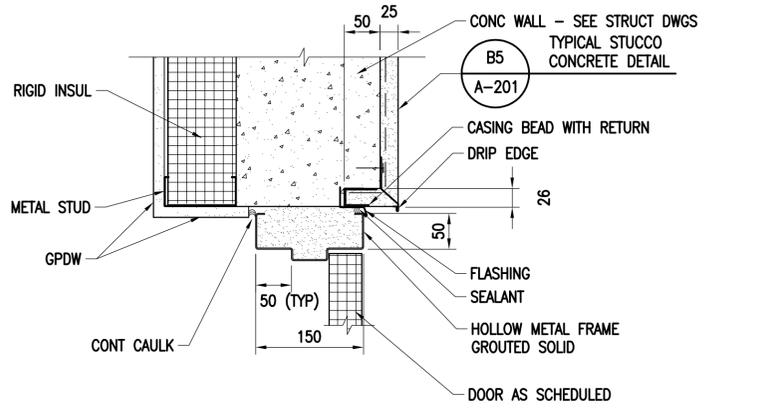

DOOR HEAD DETAIL
SCALE: 1:5 A-601 (B4)

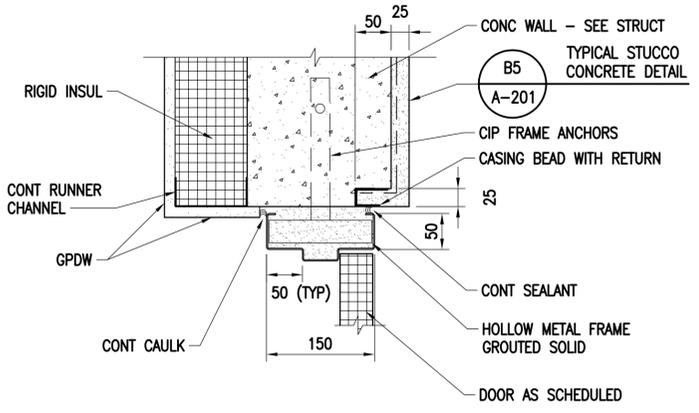

DOOR JAMB DETAIL
SCALE: 1:5 A-601 (A4)

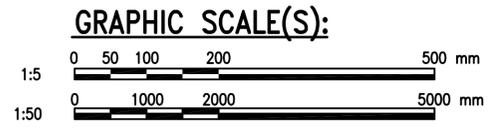

APPR	
DATE	
SYN	DESCRIPTION
PAUL W. SHOPE JR. Lic. No. 12110	
APPROVED	A/E INFO
FOR COMMANDER NAVFAC	ACTIVITY
SATISFACTORY TO	DATE
DES PWS	DRW JRW
CHK CBL	
BRANCH MANAGER	
CHIEF ENG/ARCH	
DATE	
DEPARTMENT OF THE NAVY	NAVFACILITIES ENGINEERING COMMAND
ATLANTIC DIVISION	NORFOLK, VIRGINIA
CAMP LEMONIER	DJIBOUTI, AFRICA
DESC 1701/P-1701	
CONSTRUCT FUEL STORAGE FACILITIES	
DOOR DETAILS	
SCALE:	AS NOTED
PROJECT NO.:	
WORK ORDER NO.:	
NAVFAC DRAWING NO.:	14047064
SHEET	100 OF 186
A-502	
<small>DRAWING REVISION: 10 MARCH 2009</small>	

FILE NAME: G:\14 Jobs\14-013 Djibouti - Fuel Storage Facility - NAVFAC LANT\1404 AutoCAD\VA-601 BUILDING SCHEDULES.dwg LAYOUT NAME: BUILDING SCHEDULES PLOTTED: Friday, March 25, 2016 - 8:41 am USER: whermann

DOOR SCHEDULE

NUMBER	FIRE RATING	DOOR			FRAME			HARDWARE SET	REMARK		
		SIZE	TYPE	MATERIAL	TYPE	MATERIAL	DETAILS				
							HEAD			JAMB	THOLD
PUMPHOUSE NUMBER 5											
P101.1	--	PAIR - 914 x 2133 x 44	NL	HM	1	HM	B1/A-502	A1/A-502	A2/A-502	HW-01	
P101.2	--	914 x 2133 x 44	NL	HM	1	HM	B1/A-502	A1/A-502	A2/A-502	HW-02	
PUMPHOUSE NUMBER 6											
P101.1	--	PAIR - 914 x 2133 x 44	NL	HM	1	HM	B1/A-502	A1/A-502	A2/A-502	HW-01	
P101.2	--	914 x 2133 x 44	NL	HM	1	HM	B1/A-502	A1/A-502	A2/A-502	HW-02	
FILTER BUILDING											
F101.1	--	PAIR - 914 x 2133 x 44	NL	HM	1	HM	B1/A-502	A1/A-502	A3/A-502	HW-01	
F101.2	--	PAIR - 914 x 2133 x 44	NL	HM	1	HM	B1/A-502	A1/A-502	A3/A-502	HW-01	
F102.1	--	PAIR - 914 x 2133 x 44	NL	HM	1	HM	B4/A-502	A4/A-502	B3/A-502	HW-01	
F102.2	--	914 x 2133 x 44	NL	HM	1	HM	B4/A-502	A4/A-502	B3/A-502	HW-02	
F103.1	--	914 x 2133 x 44	F	HM	1	HM	B2/A-502	B2/A-502	-	HW-03 UNDERCUT 20 mm	
F104.1	--	914 x 2133 x 44	NL	HM	1	HM	B1/A-502	A1/A-502	A3/A-502	HW-02	
OPERATIONS BUILDING											
101.1	--	914 x 2133 x 44	ES	ALUM	2	ALUM	D4/A-502	D5/A-502	C2/A-502	HW-05 BLAST RESISTANT	
101.2	--	914 x 2133 x 44	ES	ALUM	2	ALUM	D4/A-502	D5/A-502	C2/A-502	HW-05 BLAST RESISTANT	
102.1	--	914 x 2133 x 44	ES	ALUM	4	ALUM	D4/A-502	D5/A-502	C2/A-502	HW-04 BLAST RESISTANT	
103.1	--	914 x 2133 x 44	IS	ALUM	5	ALUM	C3/A-502	C3/A-502	-	HW-06	
104.1	--	914 x 2133 x 44	F	HM	1	HM	B2/A-502	B2/A-502	-	HW-07	
105.1	--	914 x 2133 x 44	F	HM	1	HM	B2/A-502	B2/A-502	-	HW-07	
106.1	--	914 x 2133 x 44	F	HM	1	HM	B2/A-502	B2/A-502	-	HW-07	
107.1	--	914 x 2133 x 44	F	HM	1	HM	B2/A-502	B2/A-502	-	HW-12	
108.1	--	914 x 2133 x 44	ES	ALUM	3	ALUM	D4/A-502	D5/A-502	C2/A-502	HW-04 BLAST RESISTANT	
109.1	--	914 x 2133 x 44	NL	HM	1	HM	B2/A-502	B2/A-502	-	HW-08	
110.1	--	914 x 2133 x 44	F	HM	1	HM	D4/A-502	D5/A-502	C2/A-502	HW-02 HEAD AND JAMB DETAILS ARE SIMILAR TO D4 AND D5/A-502	
111.1	--	914 x 2133 x 44	F	HM	1	HM	B2/A-502	B2/A-502	-	HW-03 UNDERCUT 20 mm	
112.1	--	914 x 2133 x 44	F	HM	1	HM	B2/A-502	B2/A-502	-	HW-03 UNDERCUT 20 mm	
113.1	--	914 x 2133 x 44	F	HM	1	HM	B2/A-502	B2/A-502	-	HW-11	
114.1	--	914 x 2133 x 44	F	HM	1	HM	B2/A-502	B2/A-502	-	HW-11	
115.1	--	914 x 2133 x 44	NL	HM	1	HM	B2/A-502	B2/A-502	-	HW-09	
115.2	--	914 x 2133 x 44	ES	ALUM	4	ALUM	D4/A-502	D5/A-502	C2/A-502	HW-04 BLAST RESISTANT	
116.1	--	914 x 2133 x 44	F	HM	1	HM	B2/A-502	B2/A-502	-	HW-10 UNDERCUT 20 mm	
117.1	--	914 x 2133 x 44	F	HM	1	HM	B2/A-502	B2/A-502	-	HW-10 UNDERCUT 20 mm	

NOTES:
SEE C1/A-502 FOR DOOR TYPES.
SEE D1/A-502 FOR FRAME TYPES.

PUMP HOUSE FINISH SCHEDULE

NUMBER	ROOM	FLOOR	BASE	WALLS		CEILINGS		SEE NUMBERED NOES BELOW
				MATERIAL	FINISH	MATERIAL	HEIGHT	
101	PUMP ROOM	CONC	-	CONC	NONE	CONC	-	

NOTES

ABBREVIATIONS
CONC CONCRETE (UNPAINTED)

FILTER BUILDING FINISH SCHEDULE

NUMBER	ROOM	FLOOR	BASE	WALLS		CEILINGS		SEE NUMBERED NOES BELOW
				MATERIAL	FINISH	MATERIAL	HEIGHT	
101	FILTER ROOM	CONC	-	CONC	NONE	-	-	
102	CONTROL ROOM	CT	CT	GPDW	PNTD	ACP	2740	
103	TOILET	CT	CT	GPDW	PNTD	ACP	2440	
104	MECHANICAL	CONC	-	CONC	-	GPDW	3630	

NOTES

ABBREVIATIONS
ACP ACOUSTIC CEILING PANELS
CONC CONCRETE (UNPAINTED)
CT CERAMIC TILE
GPDW GYPSUM DRYWALL
PNTD PAINTED

OPERATIONS BUILDING FINISH SCHEDULE

NUMBER	ROOM	FLOOR	BASE	WALLS		CEILINGS		SEE NUMBERED NOES BELOW
				MATERIAL	FINISH	MATERIAL	HEIGHT	
101	FUELS LAB	SRCT	CT-2	GPDW	PNT-1	ACP	2440	
102	CUSTOMER AREA	EG	CT-2	GPDW	PNT-1	ACP	2750	
103	OPEN OFFICE	CT-1	CT-2	GPDW	PNT-1	ACP	2750	
104	OFFICE	CT-1	CT-2	GPDW	PNT-1	ACP	2440	
105	OFFICE	CT-1	CT-2	GPDW	PNT-1	ACP	2440	
106	OFFICE	CT-1	CT-2	GPDW	PNT-1	ACP	2440	
107	COMMUNICATIONS	CT-1	CT-2	GPDW	PNT-1	ACP	2440	
108	CORRIDOR	CT/EG	CT-2	GPDW	PNT1	ACP	2440	
109	CONFERENCE	CT-1	CT-2	GPDW	PNT-1	ACP	2440	
110	ELEC/DATA	--	CT-2	GPDW	PNT-1	ACP	2440	
111	TOILET	CT-1	CT-2	CT-3	-	ACP	2440	
112	EASTERN TOILET	CT-1	CT-2	CT-3	-	ACP	2440	
113	WOMEN'S LOCKER ROOM	CT-1	CT-2	CT-3	-	APC/GPDW	2440	
114	MEN'S LOCKER ROOM	CT-1	CT-2	CT-3	-	APC/GPDW	2440	
115	BREAK ROOM	CT-1	CT-2	GPDW	PNT-1	ACP	2440	
116	JANITOR CLOSET	CT-1	CT-2	GPDW	PNT-1	GPDW	2440	
117	MECHANICAL ROOM	--	CT-2	GPDW	PNT-1	ACP	2440	

GENERAL NOTE: SEE INTERIOR FINISH PRODUCT AND COLOR SELECTIONS ON A-602

DATE	APPR
DESCRIPTION	SYN
 COMMONWEALTH OF VIRGINIA PAUL W. SHOPE JR. Lic. No. 12110 ARCHITECT	
Austin Brockenbrough ENGINEERING - CONSULTING	
APPROVED	ACTIVITY
SATISFACTORY TO	DATE
DES PWS	DRW JRW
CHK JTR	
BRANCH MANAGER	
CHIEF ENG/ARCH	
DEPARTMENT OF THE NAVY NAVAL FACILITIES ENGINEERING COMMAND NORFOLK, VIRGINIA DIBOUTI AFRICA CAMP LEMONNIER DESC 1701/P-1701 CONSTRUCT FUEL STORAGE FACILITIES BUILDING SCHEDULES	
SCALE:	AS NOTED
PROJECT NO.:	
WORK ORDER NO.:	
NAVFAC DRAWING NO.:	14047066
SHEET	102 OF 186
A-601	
DRAWING REVISION: 10 MARCH 2009	

FILE NAME: G:\14_Jobs\14-013_Dibouti - Fuel Storage Facility - NAVFAC LANTCOM AutoCAD\VA-602 BUILDING SCHEDULES.dwg LAYOUT NAME: BUILDING SCHEDULES PLOTTED: Friday, March 25, 2016 - 8:41 am USER: wheremom

BUILDING EXTERIOR COLOR LEGEND

NOTE: MANUFACTURERS' NAMES ARE FOR REFERENCE ONLY AND ARE NOT INTENDED TO LIMIT COMPETITION. SIMILAR PRODUCTS BY OTHER MANUFACTURERS MAY BE USED. SUBMIT SAMPLES OF PRODUCTS OF MANUFACTURERS NOT INDICATED FOR APPROVAL.

MATERIAL	COLOR SELECTION
STUCCO COLOR 'A' FOR WALLS	MERLEX STUCCO COLOR P-174 DESERT BEIGE
STUCCO COLOR 'B' FOR WALLS	MERLEX STUCCO COLOR P-450 CAFE MOCHA
METAL STANDING SEAM ROOF	ATAS STOCK COLOR SANDSTONE (06)
ALUMINUM STOREFRONT DOORS AND FRAMES	CLEAR ANODIZED ALUMINUM
TRIM AND GUTTERS	MATCH ROOF COLOR
DOWNSPOUTS	MATCH ROOF COLOR
WINDOWS	CLEAR ANODIZED ALUMINUM
SUN SHADES	CLEAR ANODIZED ALUMINUM

BUILDING INTERIOR COLOR LEGEND

NOTE: MANUFACTURERS' NAMES ARE FOR REFERENCE ONLY AND ARE NOT INTENDED TO LIMIT COMPETITION. SIMILAR PRODUCTS BY OTHER MANUFACTURERS MAY BE USED. SUBMIT SAMPLES OF PRODUCTS OF MANUFACTURERS NOT INDICATED FOR APPROVAL.

MATERIAL	COLOR/PRODUCT SELECTION
ACP - ACOUSTIC CEILING PANELS	ARMSTRONG DUNE SECOND LOOK 1174, ANGLED TEGULAR 25 MM EDGE, COLOR - WHITE.
CT-1 CERAMIC FLOOR TILE	CROSSVILLE CROSS COLORS, SIZE - 305 MM X 305 MM, COLOR - A740 NUTMEG, FINISH - UPS (UNPOLISHED), INSTALLATION - SQUARE GRID PATTERN
CT-2 CERAMIC TILE BASE	CROSSVILLE CROSS COLORS COVE BASE, SIZE - 152 MM X 203 MM, COLOR - A740 NUTMEG, FINISH - UPS (UNPOLISHED),
CT-3 CERAMIC WALL TILE	CROSSVILLE CROSS COLORS, SIZE - 203 MM X 203 MM, COLOR - A235 SAHARA DUNE, FINISH - UPS (UNPOLISHED), INSTALLATION - SQUARE GRID PATTERN
EG - ENTRANCE GRID	C/S PEDISYSTEM WITH CARPET TREAD INSERTS, CARPET COLOR 9301 SILVERADO
PLAM - PLASTIC LAMINATE FOR CABINETS	WILSONART 4651-60, COLOR - NAVY LEGACY, USED FOR CABINETS IN BREAKROOM 115 AND OPEN OFFICE 103
PNT-1 PAINT FOR WALLS	SHERWIN-WILLIAMS, COLOR - SW 6140 MODERATE WHITE, FINISH - EGGSHELL
PNT-2 PAINT FOR GPDW CEILINGS	SHERWIN-WILLIAMS, COLOR - SW 7007 CEILING BRIGHT WHITE, FINISH - SEMI-GLOSS
PNT-3 PAINT FOR INTERIOR DOORS, FRAMES	SHERWIN-WILLIAMS, COLOR - SW 6107 NOMADIC DESERT, FINISH - SEMI-GLOSS
SRCT - SLIP RESISTANT CERAMIC TILE	CROSSVILLE CROSS COLORS, SIZE - 305 MM X 305 MM, COLOR - A740 NUTMEG, FINISH - CGS (CROSS-GRIP), INSTALLATION - SQUARE GRID PATTERN, IN FUELS LAB 101
SS-1 SOLID SURFACE FOR COUNTERTOPS	CORIAN, COLOR - MAUI, USED FOR COUNTERTOPS AND BACKSPLASH IN BREAKROOM 115 AND OPEN OFFICE 103
SS-2 SOLID SURFACE FOR SHOWER SURROUND	INPRO BIOPRISM, COLOR - WHITE SAND P9002, USED FOR SHOWER PAN AND SHOWER SURROUND
METAL TOILET PARTITIONS	BRADLEY CORPORATION, ALMOND 2103
METAL LOCKERS	PENCO 012 TAWNY TAN
METAL LABORATORY CASEWORK	KEWAUNEE SCIENTIFIC STEEL CASEWORK, COLOR NO. 90 AMAZON
EPOXY RESIN LABORATORY COUNTERTOPS	KEWAUNEE SCIENTIFIC KEMRESIN, BLACK
WINDOW ROLLERSHADES	MECHOSYSTEMS THERMOVEIL BASKET WEAVE SHADECLOTH, COLOR - STRAW 1317

TOILET ACCESSORY SCHEDULE

ITEM NO.	ITEM DESCRIPTION
1	SURFACE MOUNTED MULTI-ROLL TOILET TISSUE DISPENSER
2	914 mm GRAB BAR, CONCEALED MOUNTING W/ SNAP FLANGE, SATIN FINISH
3	1067 mm GRAB BAR, CONCEALED MOUNTING W/ SNAP FLANGE, SATIN FINISH
4	457 mm GRAB BAR, CONCEALED MOUNTING W/ SNAP FLANGE, SATIN FINISH
5	GLASS MIRROR W/STAINLESS STEEL ANGLE FRAME
6	SURFACE MOUNTED STAINLESS STEEL SOAP DISPENSER
7	SURFACE MOUNTED ROLL PAPER TOWEL DISPENSER
8	SURFACE MOUNTED SANITARY NAPKIN DISPOSAL
9	HORIZONTAL TWO-WALL GRAB BAR FOR SHOWER STALL W/ SNAP FLANGE, SATIN FIN.
10	REVERSIBLE SOLID PHENOLIC FOLDING SHOWER SEAT
11	HEAVY DUTY TOWEL PIN W/ CONCEALED MOUNTING
12	SHOWER CURTAIN ROD W/ CONCEALED MOUNTING, +/-1220 mm LENGTH (FIELD VERIFY)
13	NOT USED
14	STAINLESS STEEL SHOWER CURTAIN HOOK, QUANTITY = 12, AND CURTAIN
15	SHOWER CURTAIN ROD W/ CONCEALED MOUNTING, +/- 914 mm LENGTH (FIELD VERIFY)
16	NOT USED
17	STAINLESS STEEL SHOWER CURTAIN HOOK, QUANTITY = 7, AND CURTAIN
18	MOP AND BROOM HOLDER



Austin
Brockenbrough
ENGINEERING - CONSULTING

APPROVED
FOR COMMANDER NAVFAC
ACTIVITY
SATISFACTORY TO DATE
DES: PWS | DRW: JRW | CHK: JTR
BRANCH MANAGER
CHIEF ENG/ARCH
<<CR>>

DEPARTMENT OF THE NAVY
ATLANTIC DIVISION
CAMP LEMONNIER
NAVAL FACILITIES ENGINEERING COMMAND
NORFOLK, VIRGINIA
DIBOUTI, AFRICA
DESC 1701/P-1701
CONSTRUCT FUEL STORAGE FACILITIES
BUILDING SCHEDULES

SCALE: AS NOTED
PROJECT NO.:
WORK ORDER NO.:
NAVFAC DRAWING NO.: 14047067
SHEET 103 OF 186
A-602

DRAWING REVISION: 10 MARCH 2009