


FILE NAME: P:\VA\NavalStation Norfolk\1356201_135621_CNS Vertical Building\B_Design\Drawings\Sheet Files\08_Architectural\1356201-CNS-A-106.dwg LAYOUT NAME: A-106 PLOTTED: Wednesday, June 15, 2016 10:55am USER: smone.chilton

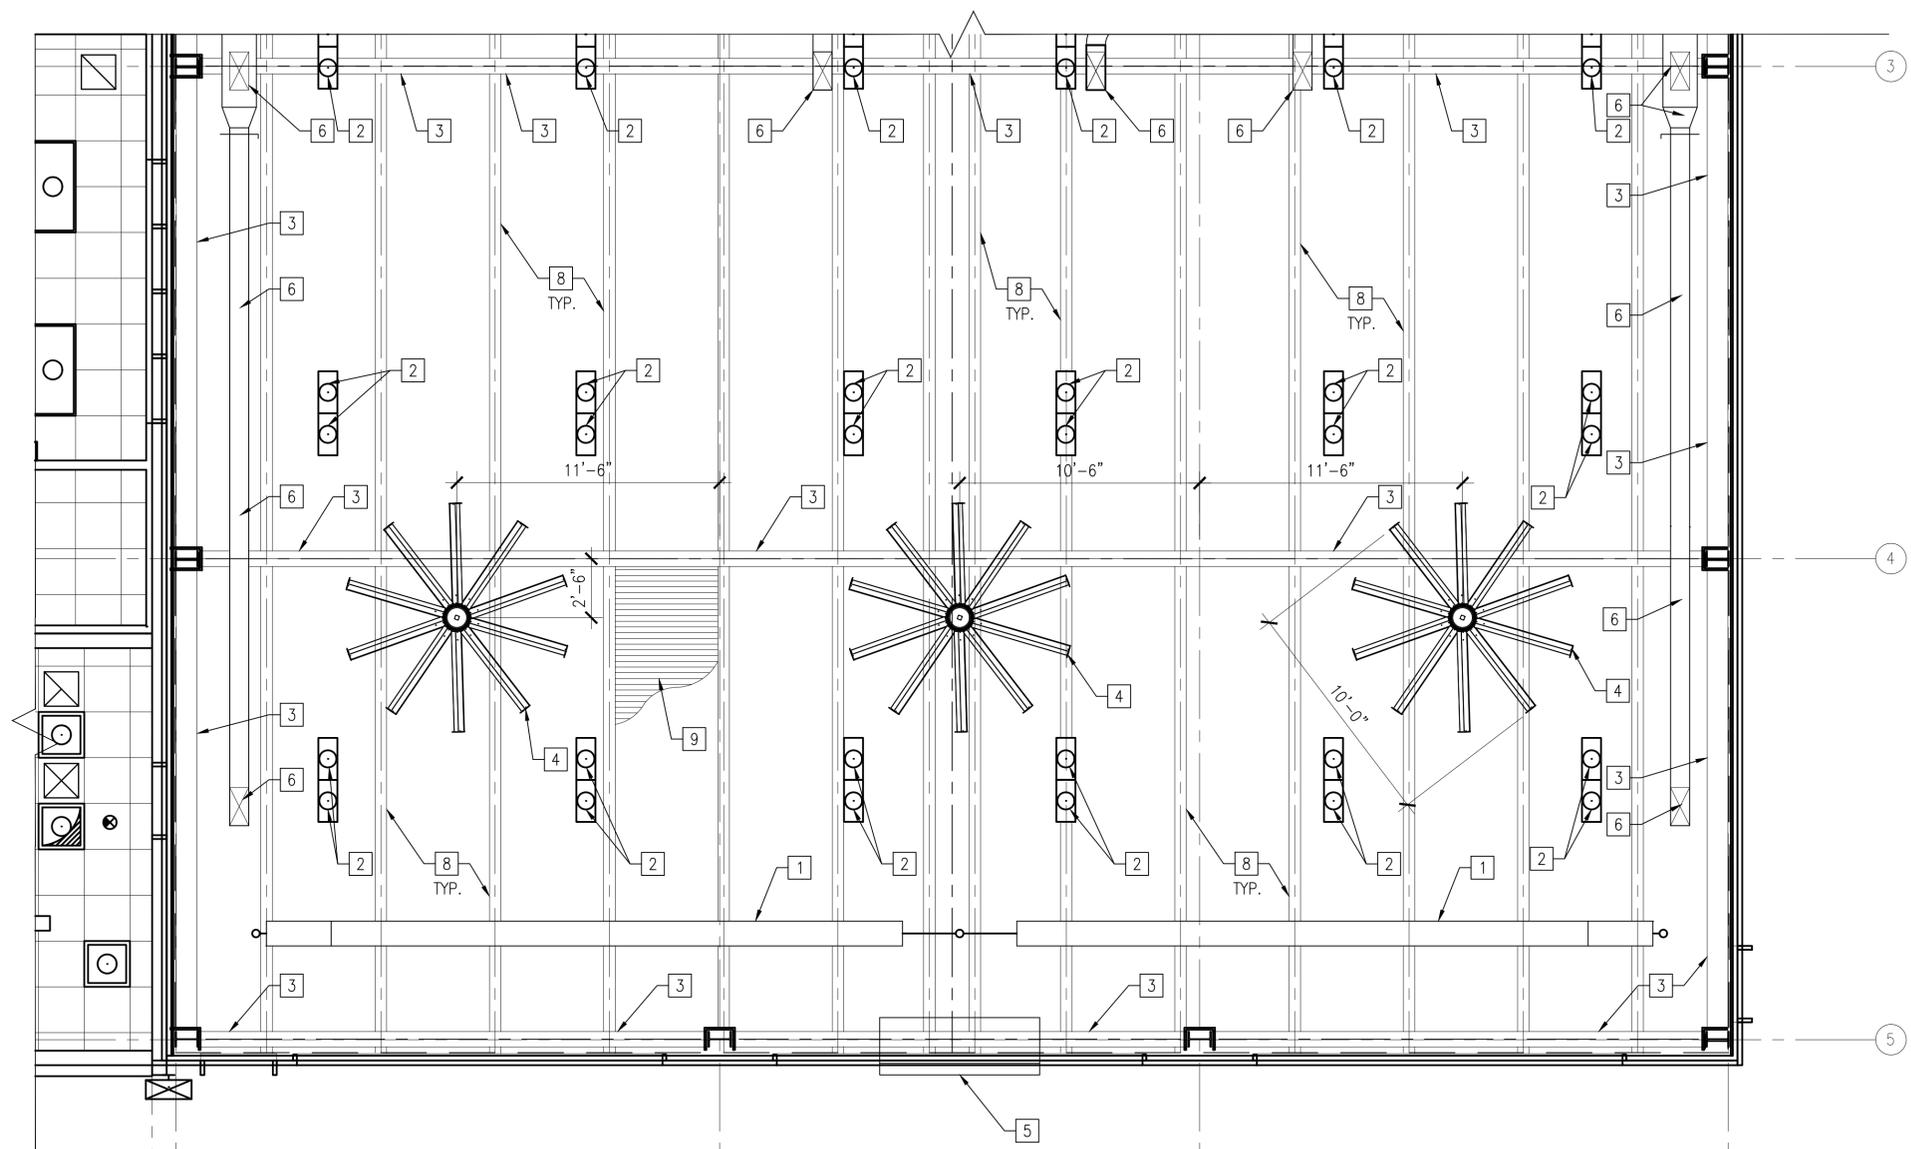

GENERAL SHEET NOTES


1. PRIOR TO PERFORMING ANY WORK, CONTRACTOR SHALL VERIFY ALL DIMENSIONS AND CONDITIONS IN THE FIELD. ANY DISCREPANCY SHALL BE BROUGHT TO THE ATTENTION OF THE CONTRACTING OFFICER PRIOR TO PERFORMING THE WORK.
2. COORDINATE WITH MECHANICAL, ELECTRICAL, STRUCTURAL AND TELECOMM DRAWINGS.
3. IF A CONFLICT OCCURS, NOTIFY THE CONTRACTING OFFICER PRIOR TO PROCEEDING.

NEW WORK KEYNOTES


1. RADIANT HEATER, PIPES AND VENT. REFER TO PLUMBING AND ELECTRICAL DRAWINGS FOR ADDITIONAL INFORMATION. METAL P.E.B. DESIGNER/MANUFACTURER TO SUBMIT MOUNTING BRACKETS AND SUPPORTS AS PART OF THEIR DESIGN PACKAGE.
2. OVERHEAD LIGHT FIXTURES. REFER TO ELECTRICAL DRAWINGS FOR ADDITIONAL INFORMATION. METAL P.E.B. DESIGNER/MANUFACTURER TO SUBMIT MOUNTING BRACKETS AND SUPPORTS AS PART OF THEIR DESIGN PACKAGE.
3. METAL BEAM OVERHEAD. METAL P.E.B. DESIGNER/MANUFACTURER TO SUBMIT MOUNTING BRACKETS AND SUPPORTS FOR EQUIPMENT, PIPING, DUCTWORK AND RELATED ITEMS AS PART OF THEIR DESIGN PACKAGE.
4. 10'-0" DIAMETER HIGH VOLUME LOW VELOCITY FAN. REFER TO MECHANICAL AND ELECTRICAL DRAWINGS FOR ADDITIONAL INFORMATION. BASIS OF DESIGN IS BIG ASS FANS POWERFOIL X 2.0. METAL P.E.B. DESIGNER/MANUFACTURER TO SUBMIT MOUNTING BRACKETS AND SUPPORTS AS PART OF THEIR DESIGN PACKAGE.
5. ELECTRONIC WIND DRIVEN RAIN RESISTANT LOUVER. REFER TO MECHANICAL AND ELECTRICAL DRAWINGS FOR ADDITIONAL INFORMATION. METAL P.E.B. DESIGNER/MANUFACTURER TO SUBMIT MOUNTING BRACKETS AND SUPPORTS AS PART OF THEIR DESIGN PACKAGE.
6. MAKEUP AIR UNIT, DUCTWORK AND REGISTERS. REFER TO MECHANICAL AND ELECTRICAL DRAWINGS FOR ADDITIONAL INFORMATION. METAL P.E.B. DESIGNER/MANUFACTURER TO SUBMIT MOUNTING BRACKETS AND SUPPORTS AS PART OF THEIR DESIGN PACKAGE.
7. NOT USED.
8. METAL PURLIN OVERHEAD. METAL P.E.B. DESIGNER/MANUFACTURER TO SUBMIT MOUNTING BRACKETS AND SUPPORTS FOR EQUIPMENT, PIPING, DUCTWORK AND RELATED ITEMS AS PART OF THEIR DESIGN PACKAGE.
9. STRUCTURAL METAL DECK OVERHEAD. REFER TO STRUCTURAL DRAWINGS FOR ADDITIONAL INFORMATION. TO AVOID CLUTTERING THE DRAWING, METAL DECK IS ONLY SHOWN IN THIS AREA, BUT IS APPLIED OVER ENTIRE PRE-ENGINEERED BUILDING.

DATE	6/15/16	JMS	APPR
DESCRIPTION	CHANGED NOTES	SM	SM
CDR K. T. BELLOMY Satisfactory to DATE 1/20/2016 DES SC EDW SC CHK JMS PM/DM S. CHRISTIAN, R.A. BRANCH MANAGER CHIEF ENGR/ARCH J. HASTE, P.E. FIRE PROTECTION			
NAVFAC ENGINEERING COMMAND NAVAL FACILITIES ENGINEERING COMMAND - MID-ATLANTIC NAVAL STATION - NORFOLK VA NORFOLK, VIRGINIA			
CVIS VERTICAL BUILDING INSPECTION BUILDING PARTIAL REFLECTED CEILING PLAN			
SCALE: AS NOTED			
EPROJCT NO.: 1356201			
CONSTR. CONTR. NO.			
NAVFAC DRAWING NO. 12,709,836			
SHEET 52 OF 122			
A-106 <small>DRAWFORM REVISION: 10 MARCH 2009</small>			

KEY PLAN

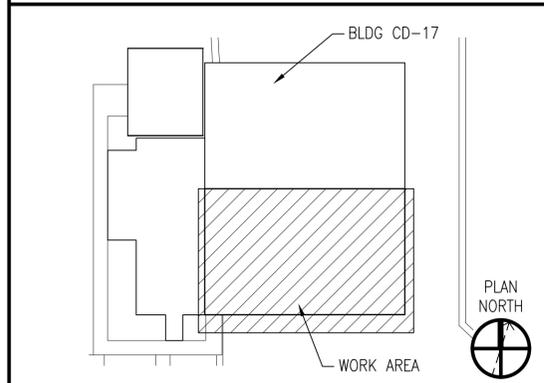

GRAPHIC SCALE

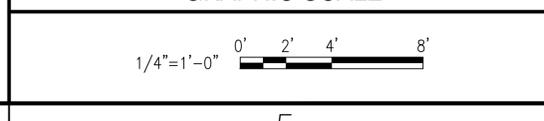

A1 INSPECTION BUILDING PARTIAL REFLECTED CEILING PLAN
SCALE: 1/4" = 1'-0"



A-100